

OMAKAU WATER SUPPLY

CONTRACT
COPY


NOT FOR USE OR
REMOVAL FROM
OFFICE


VINCENT
COUNTY COUNCIL

DUFFILL WATTS & KING LTD.
CONSULTING CIVIL & STRUCTURAL ENGINEERS
DUNEDIN, INVERCARGILL, BALCLUTHA, CROMWELL

VINCENT COUNTY COUNCIL
H.W. Felton CHAIRMAN
COUNTY CLERK

SET No.

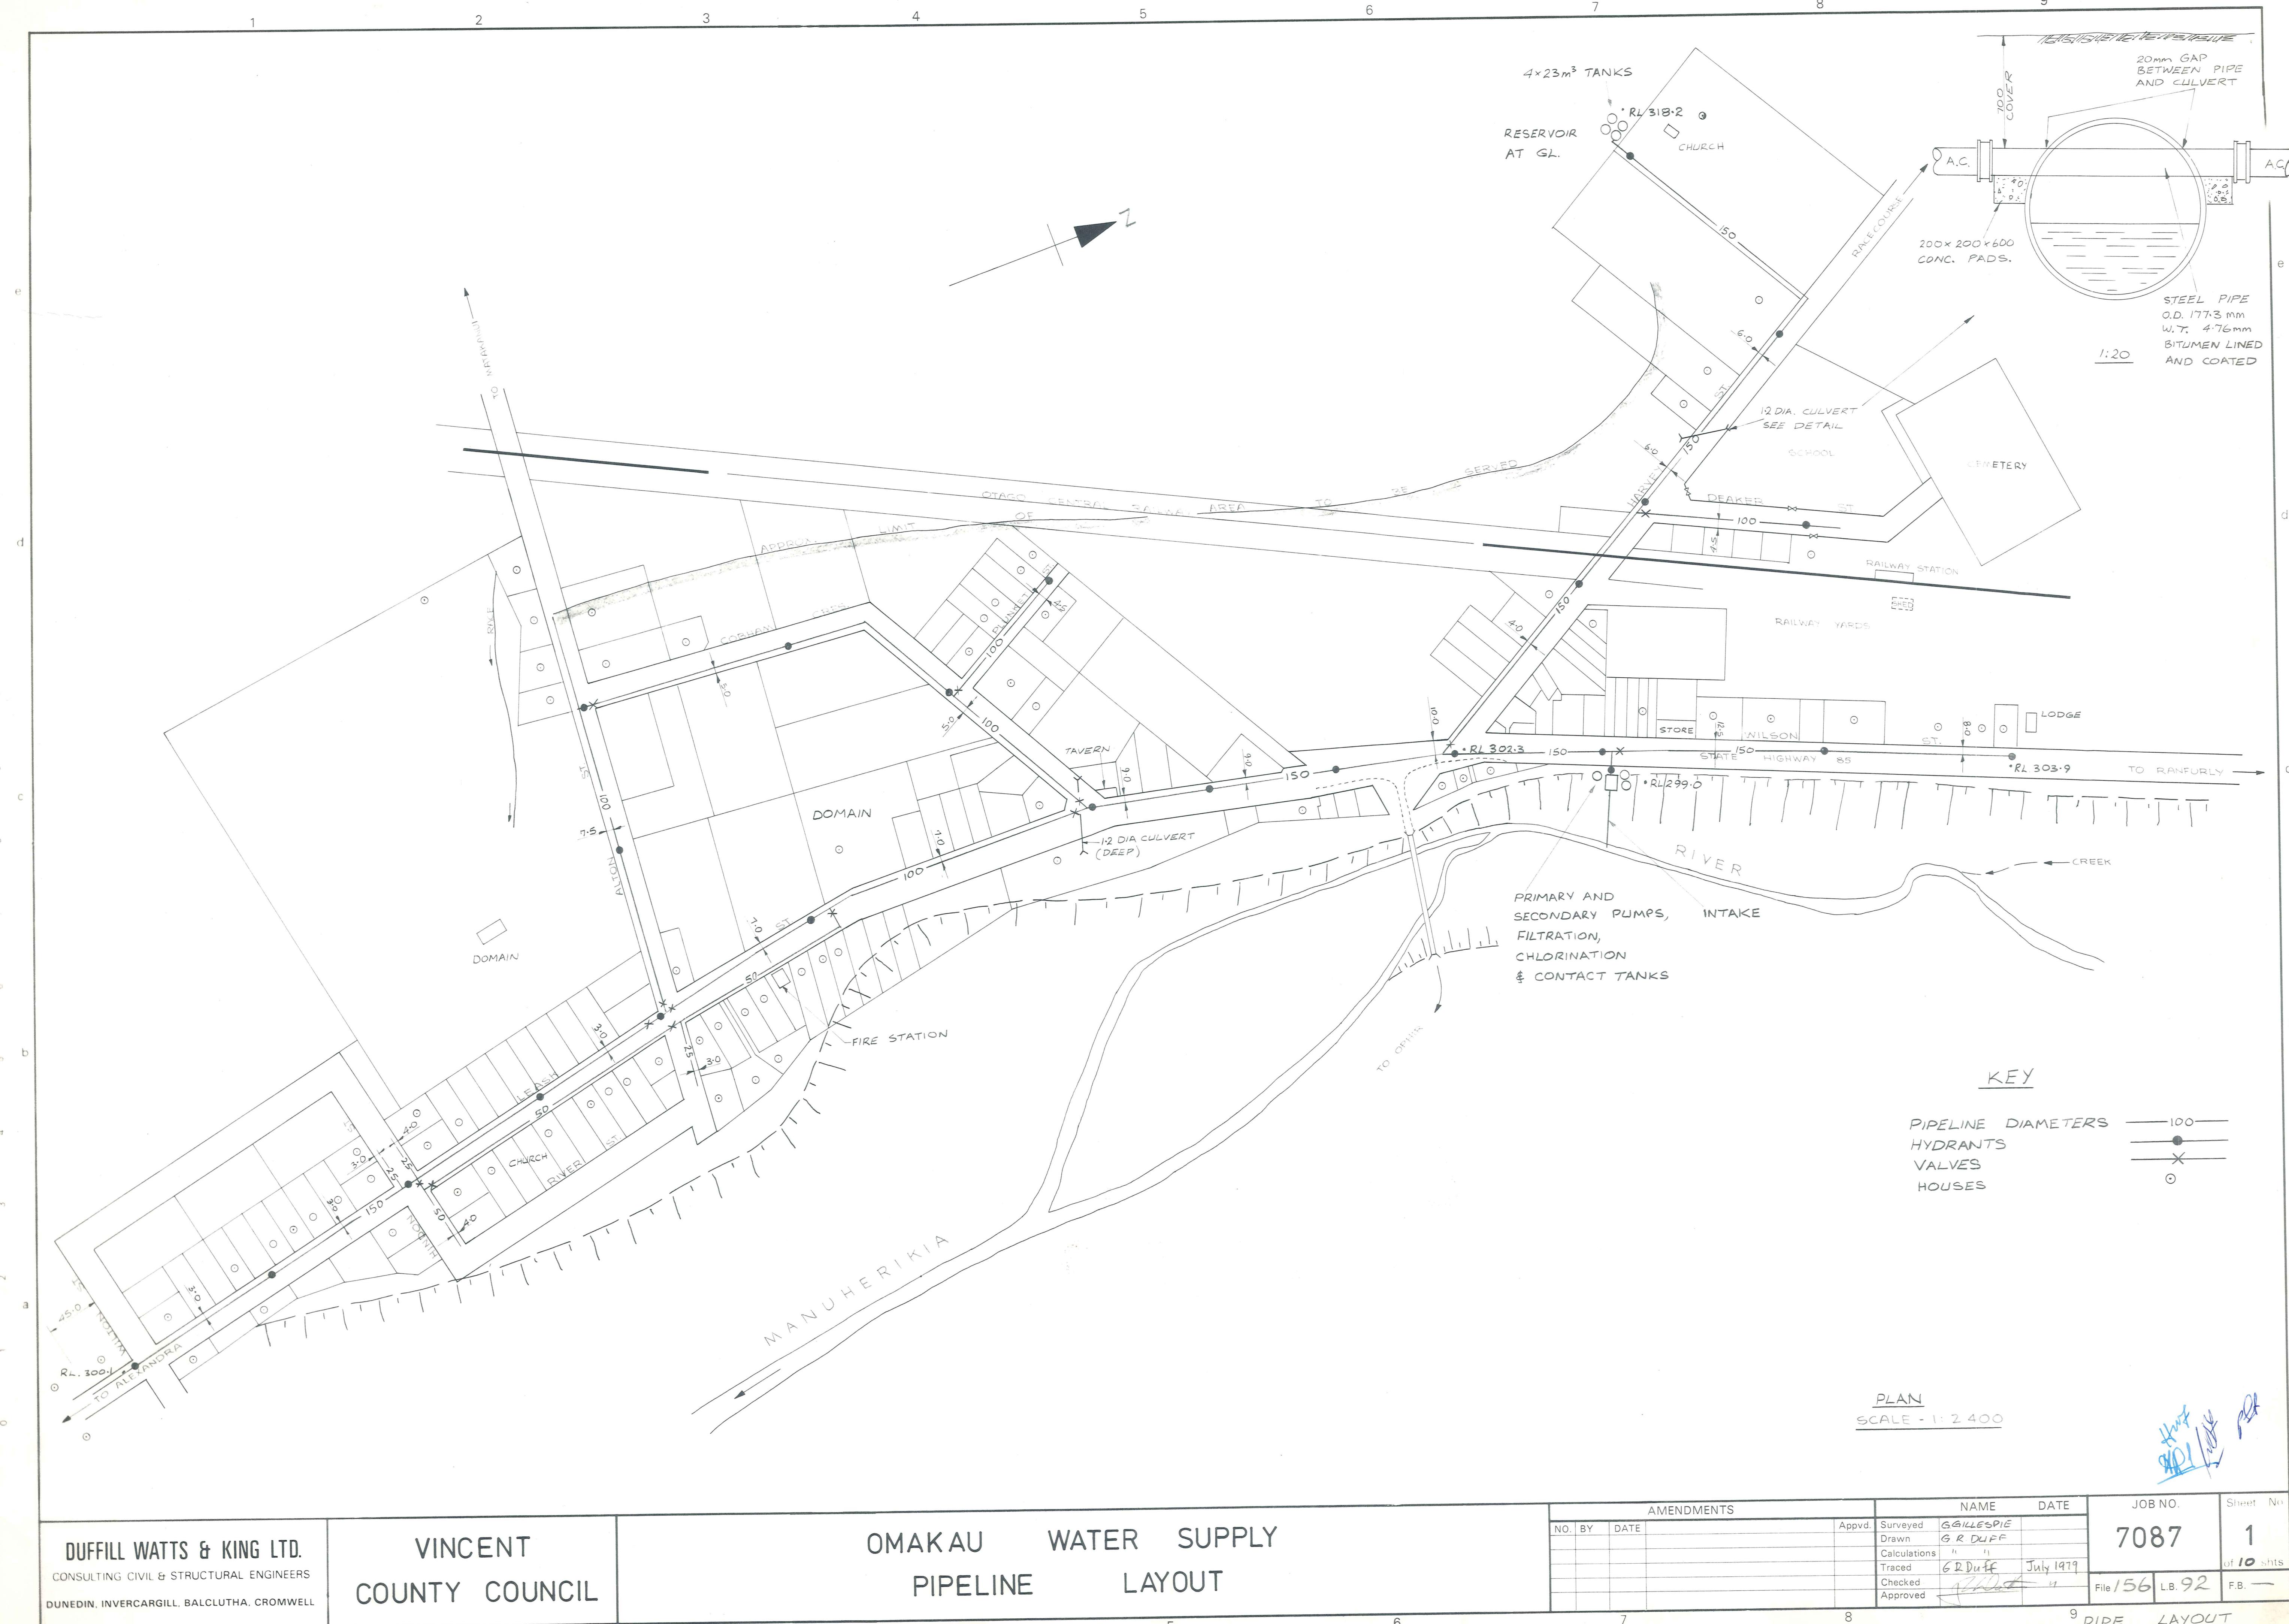

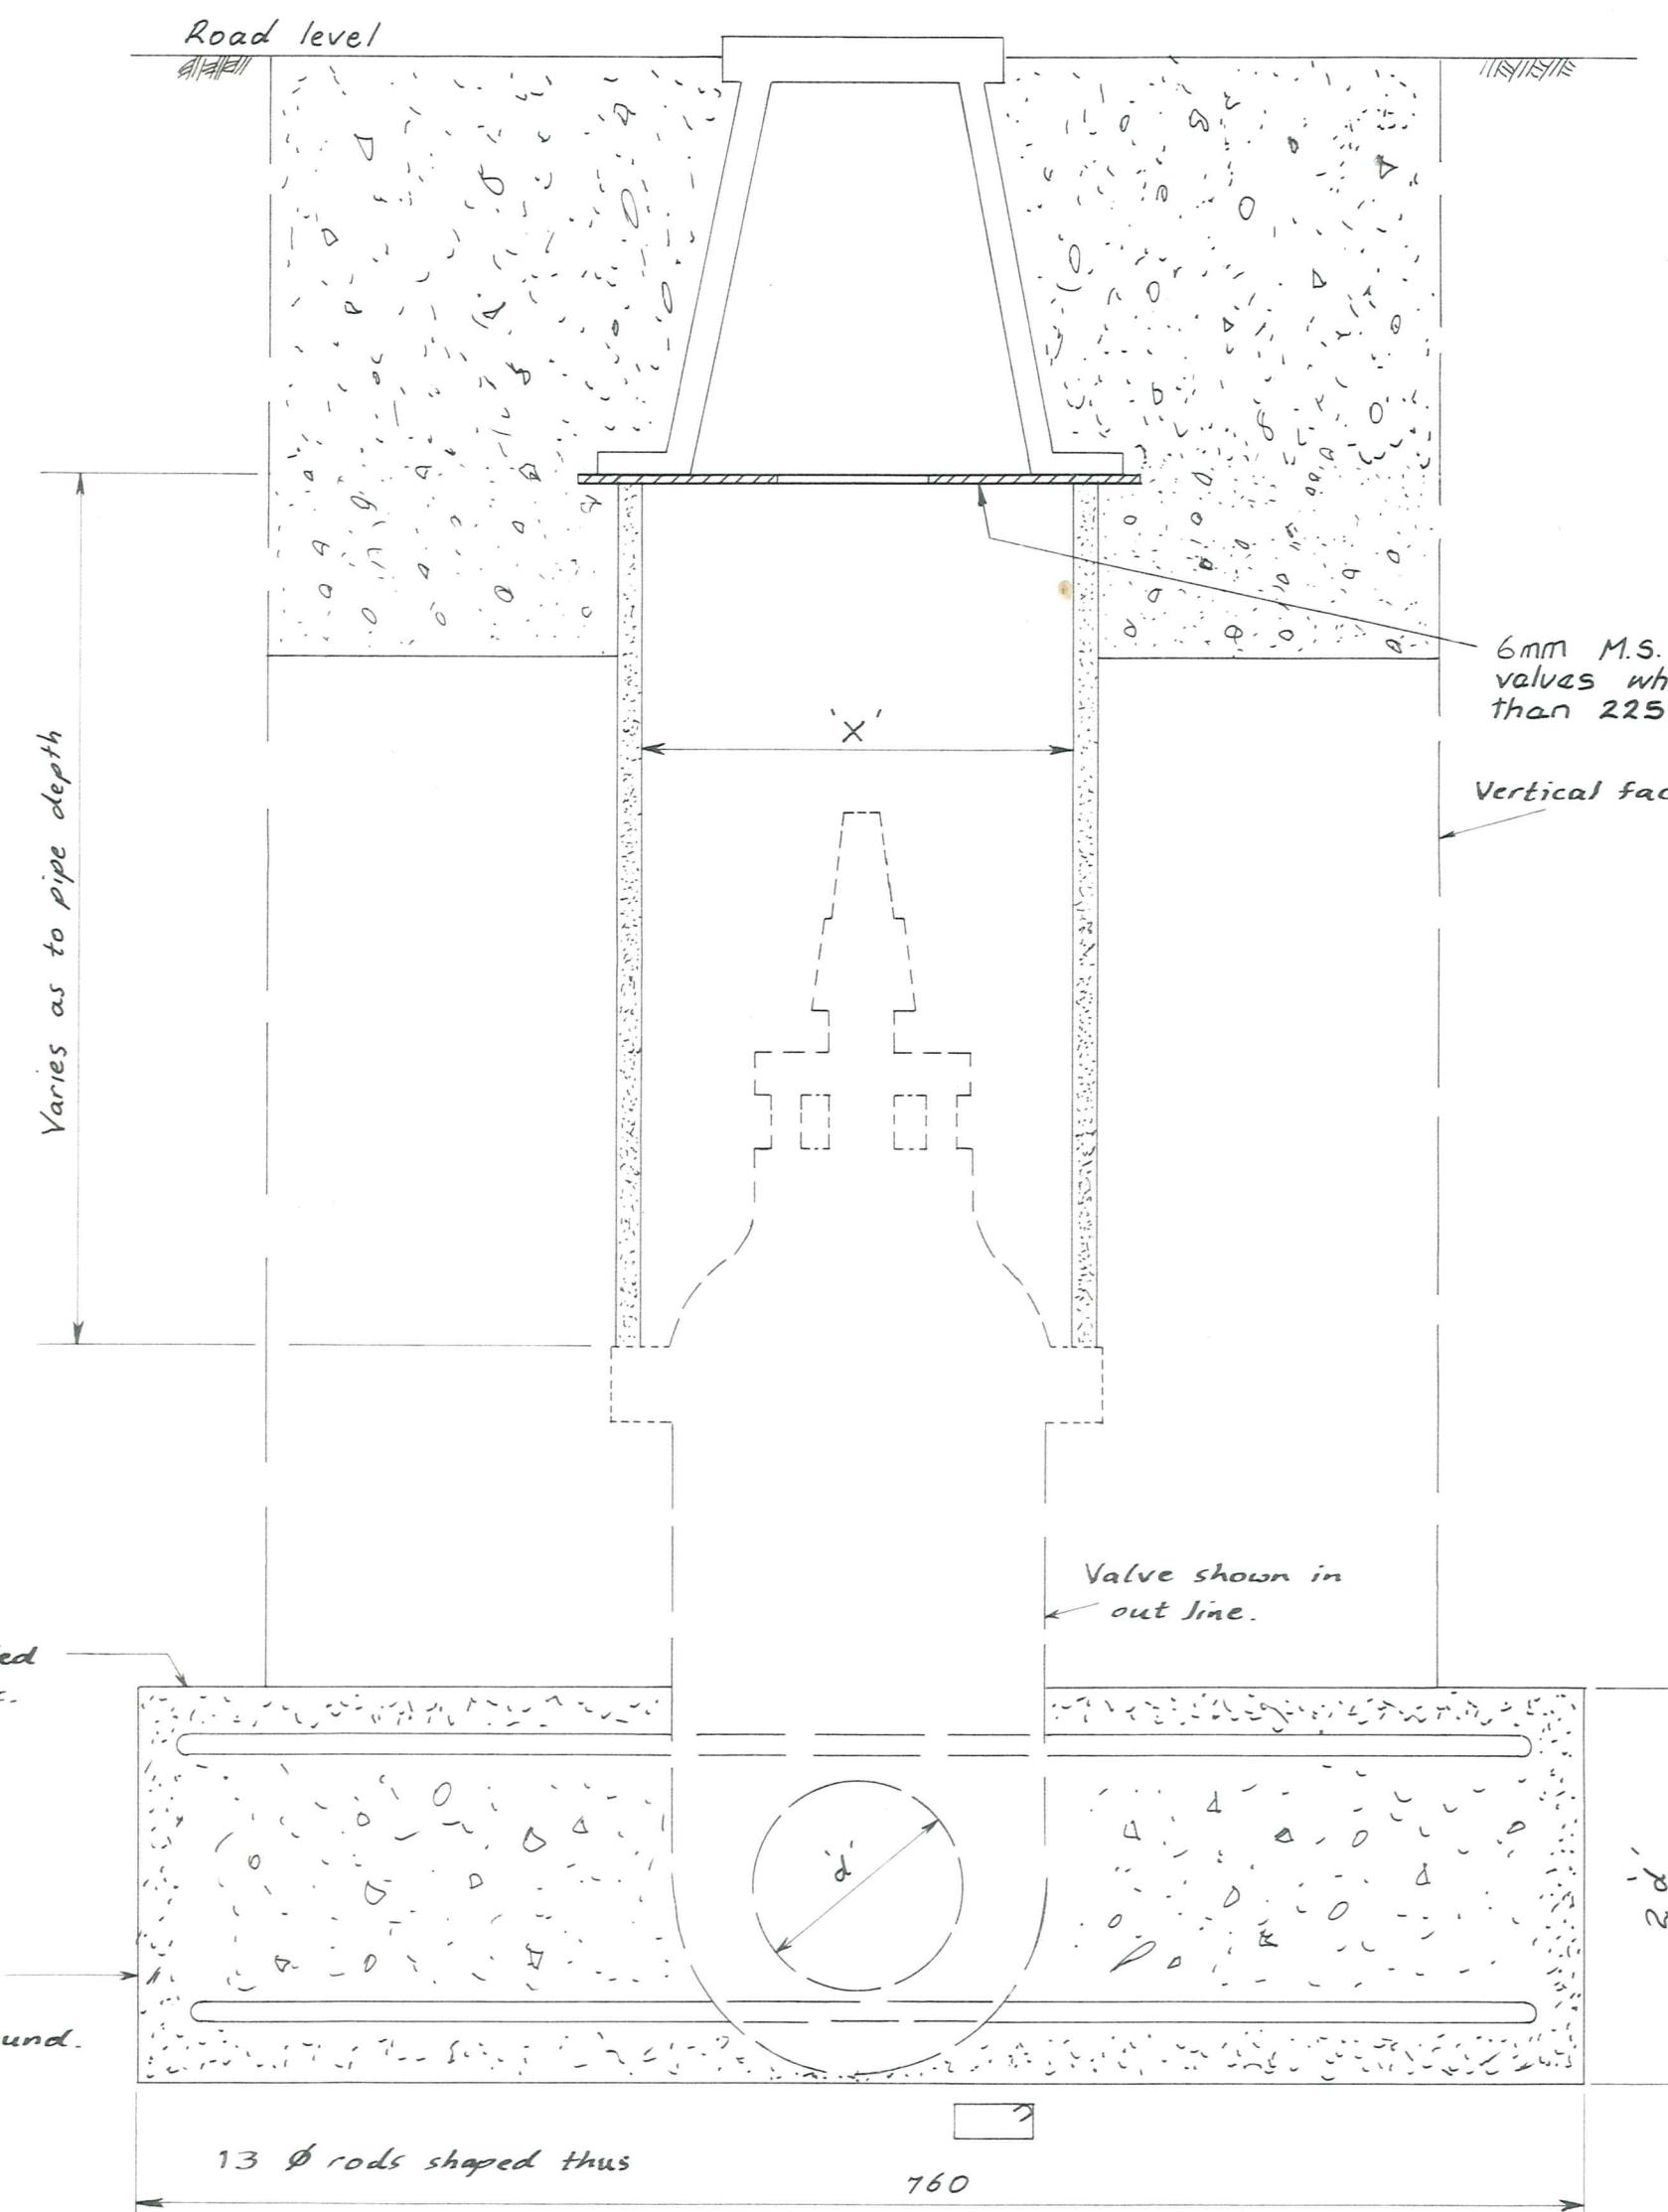


Valve Dia.	'X'	'Y'
100	225	200
150	300	225
200	375	300
250	450	375

DETAIL OF VALVE INSTALLATION


Sealed Surface: Backfill to level shown with metal or flooded sand then fill to within 20 of surface with lean mix concrete and finish with seal-coat.

Unsealed Surface: Backfill to surface with excavated material or trench-backfill and ram hard.

6mm M.S. R with hole for valves where 'X' is greater than 225 mm.

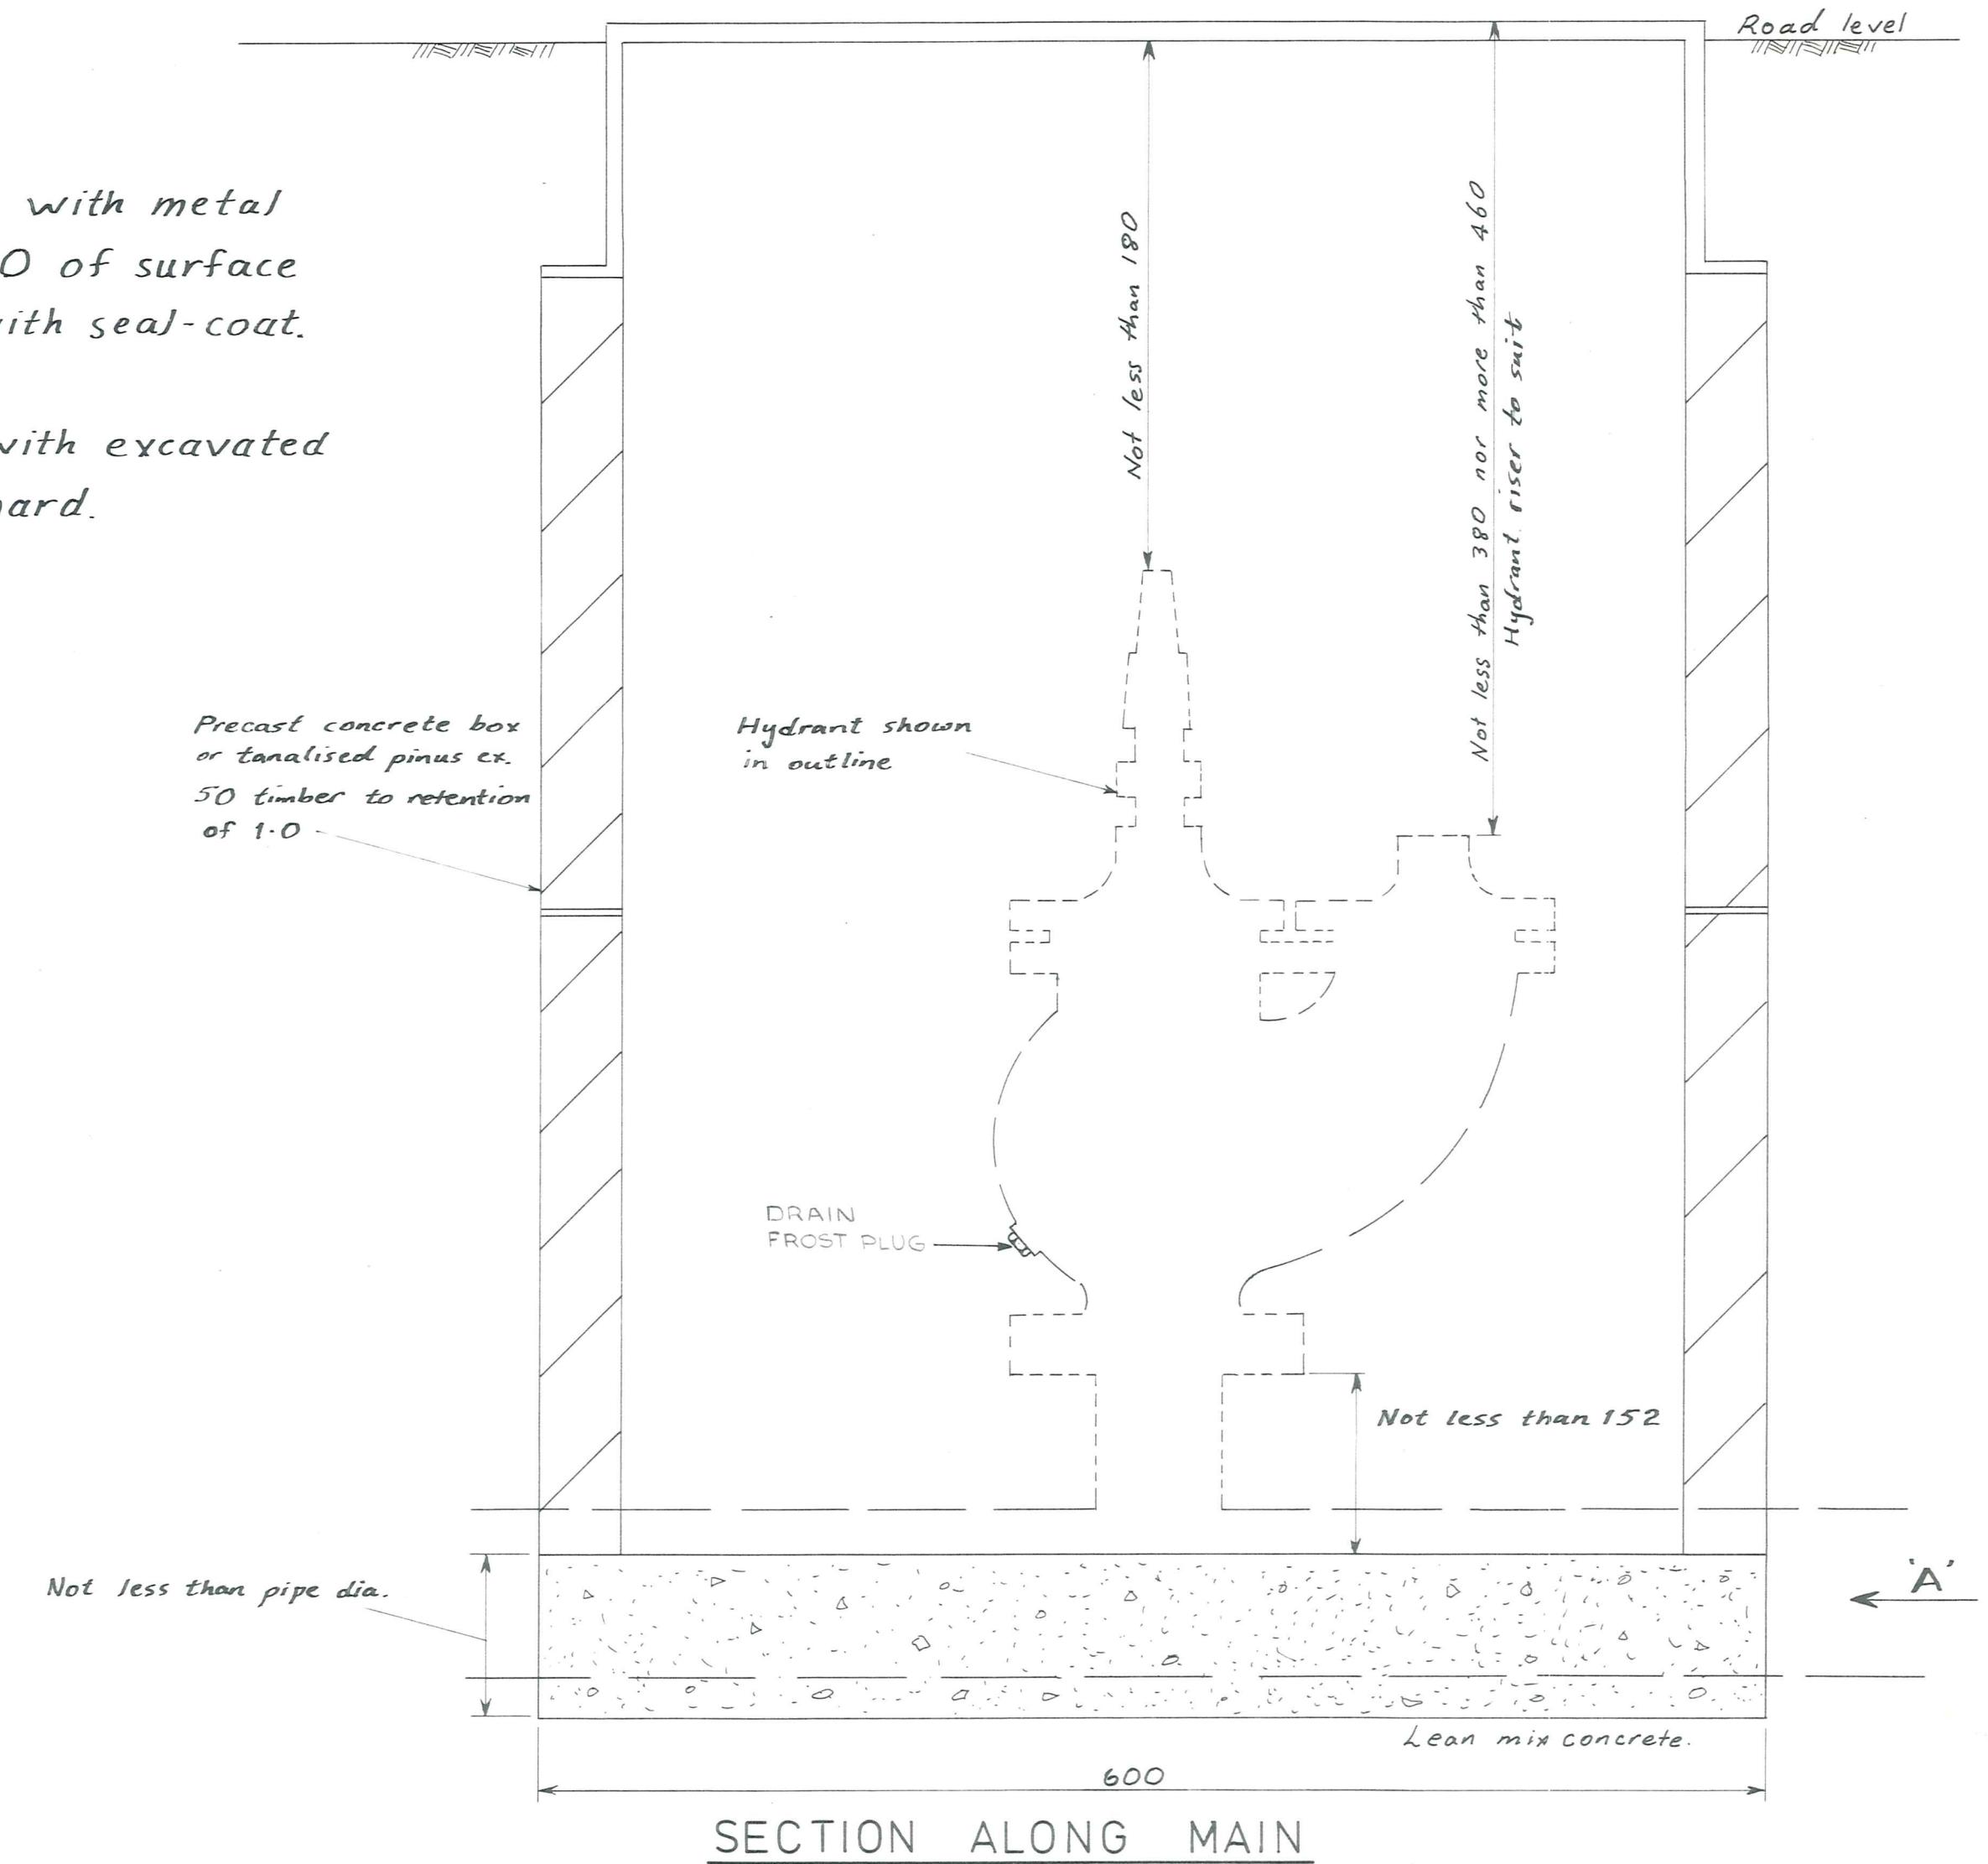

Note: Valves and Hydrants shall be marked in accordance with N.Z.S. 1152. Valve and Hydrant markers shall be erected as close as possible to property boundaries, to the closest wall of a building or the closest fence line.

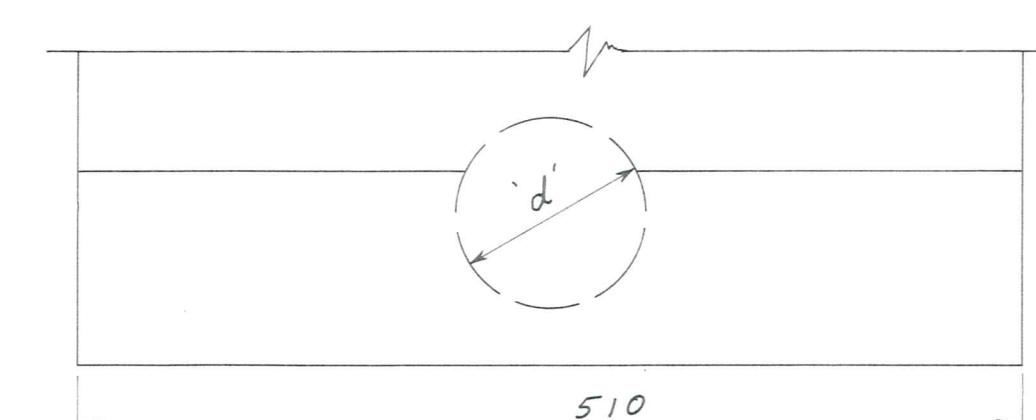


DETAIL OF HYDRANT INSTALLATION

Note: Lean mix concrete to be 12 aggregate to 1 cement to be placed fairly dry and rammed hard.


Not To Scale

1 2 3 4 5 6 7 8 9

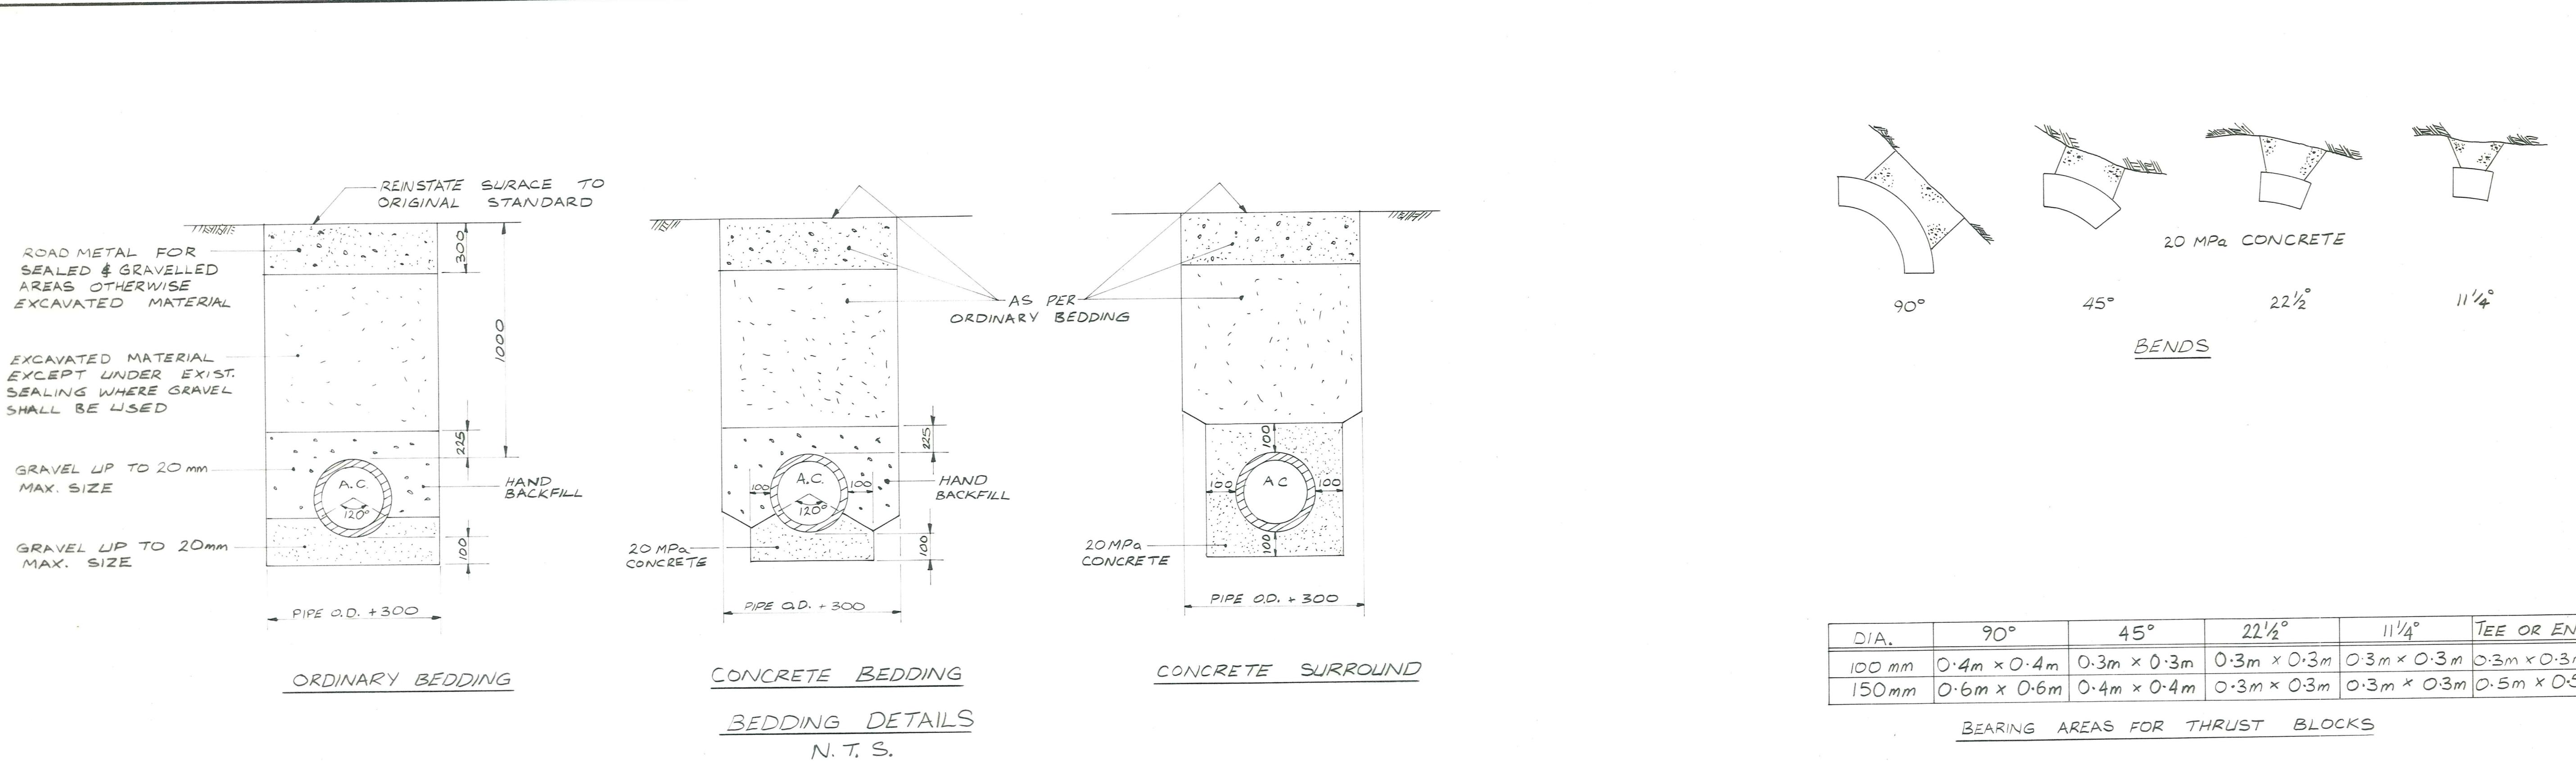

DIA.	90°	45°	22½°	11¼°	TEE OR END
100 mm	0.4m x 0.4m	0.3m x 0.3m	0.3m x 0.3m	0.3m x 0.3m	0.3m x 0.3m
150 mm	0.6m x 0.6m	0.4m x 0.4m	0.3m x 0.3m	0.3m x 0.3m	0.5m x 0.5m

BEARING AREAS FOR THRUST BLOCKS

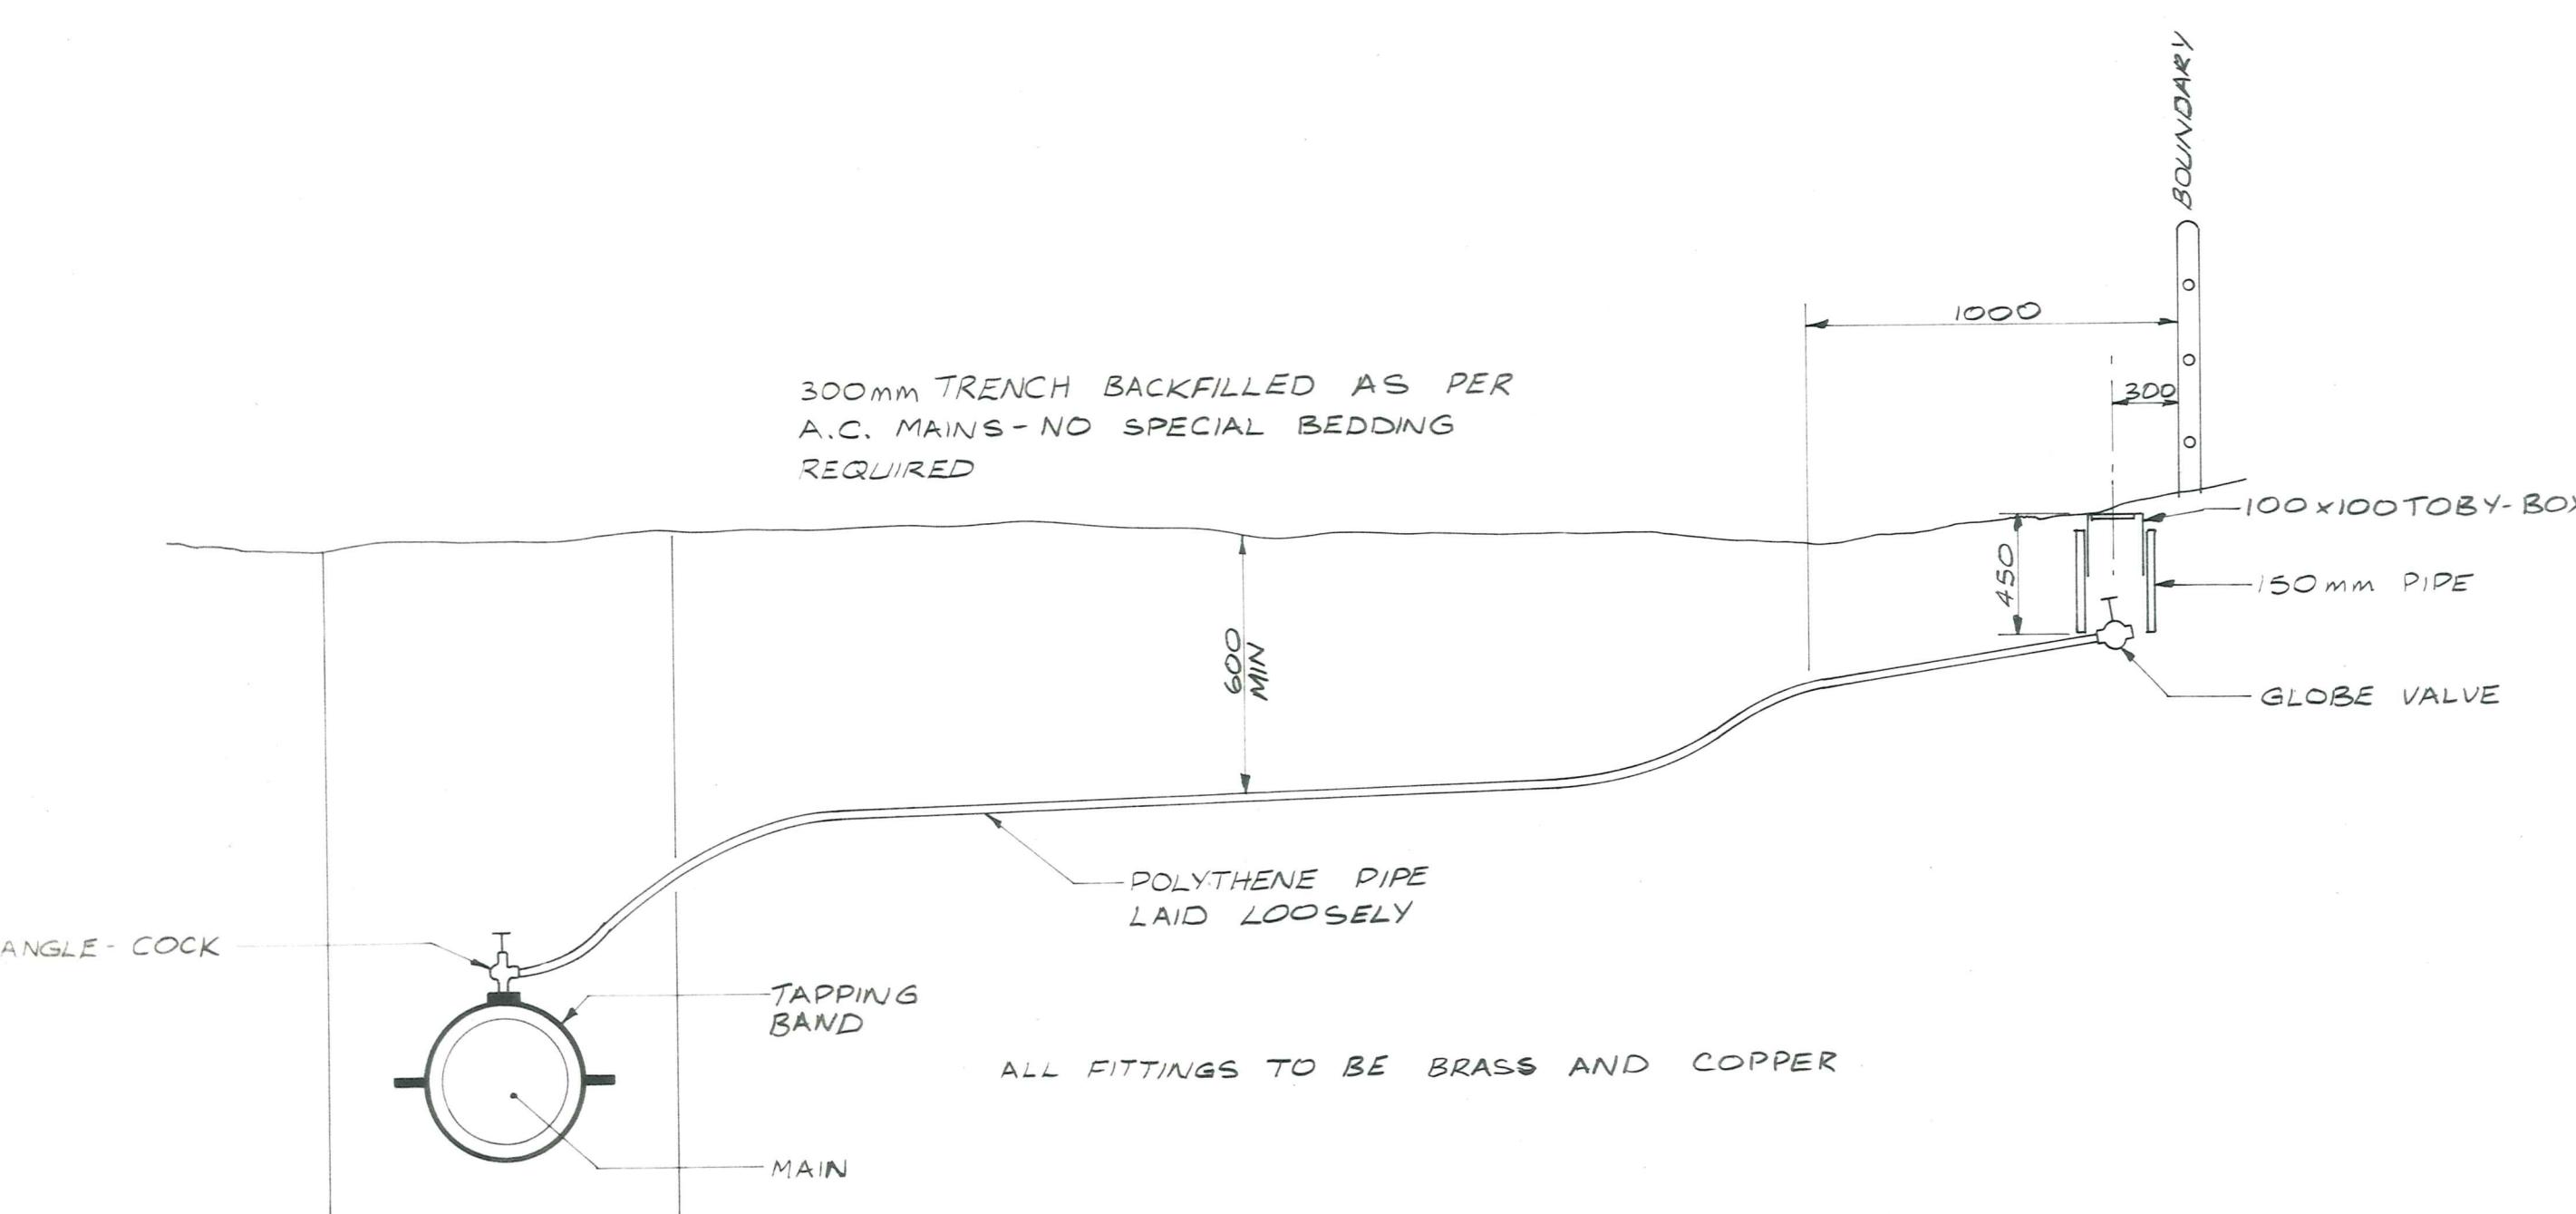


HOUSEHOLD CONNECTION DETAIL
N.T.S.


ORIGINAL SIZE mm INCHES	OMAKAU WATER SUPPLY						AMENDMENTS	NAME	DATE	JOB NO.	Sheet No
	NO.	BY	DATE	Appvd.	Surveyed	Drawn	Calculations	Traced	Checked	Approved	
DUFFILL WATTS & KING LTD CONSULTING CIVIL & STRUCTURAL ENGINEERS Dunedin PO Box 5269 Ph 777-133 Invercargill PO Box 576 Ph 83-049 Balclutha PO Box 220 Ph 81-664 Cromwell PO Box 82 Ph 50-391	VINCENT COUNTY COUNCIL										7087 of 10 shs
											File 156 L.B. 365 F.B. —


Handwritten signatures and initials are present over the bottom right corner of the table.

9

BEDDING E.T.C.

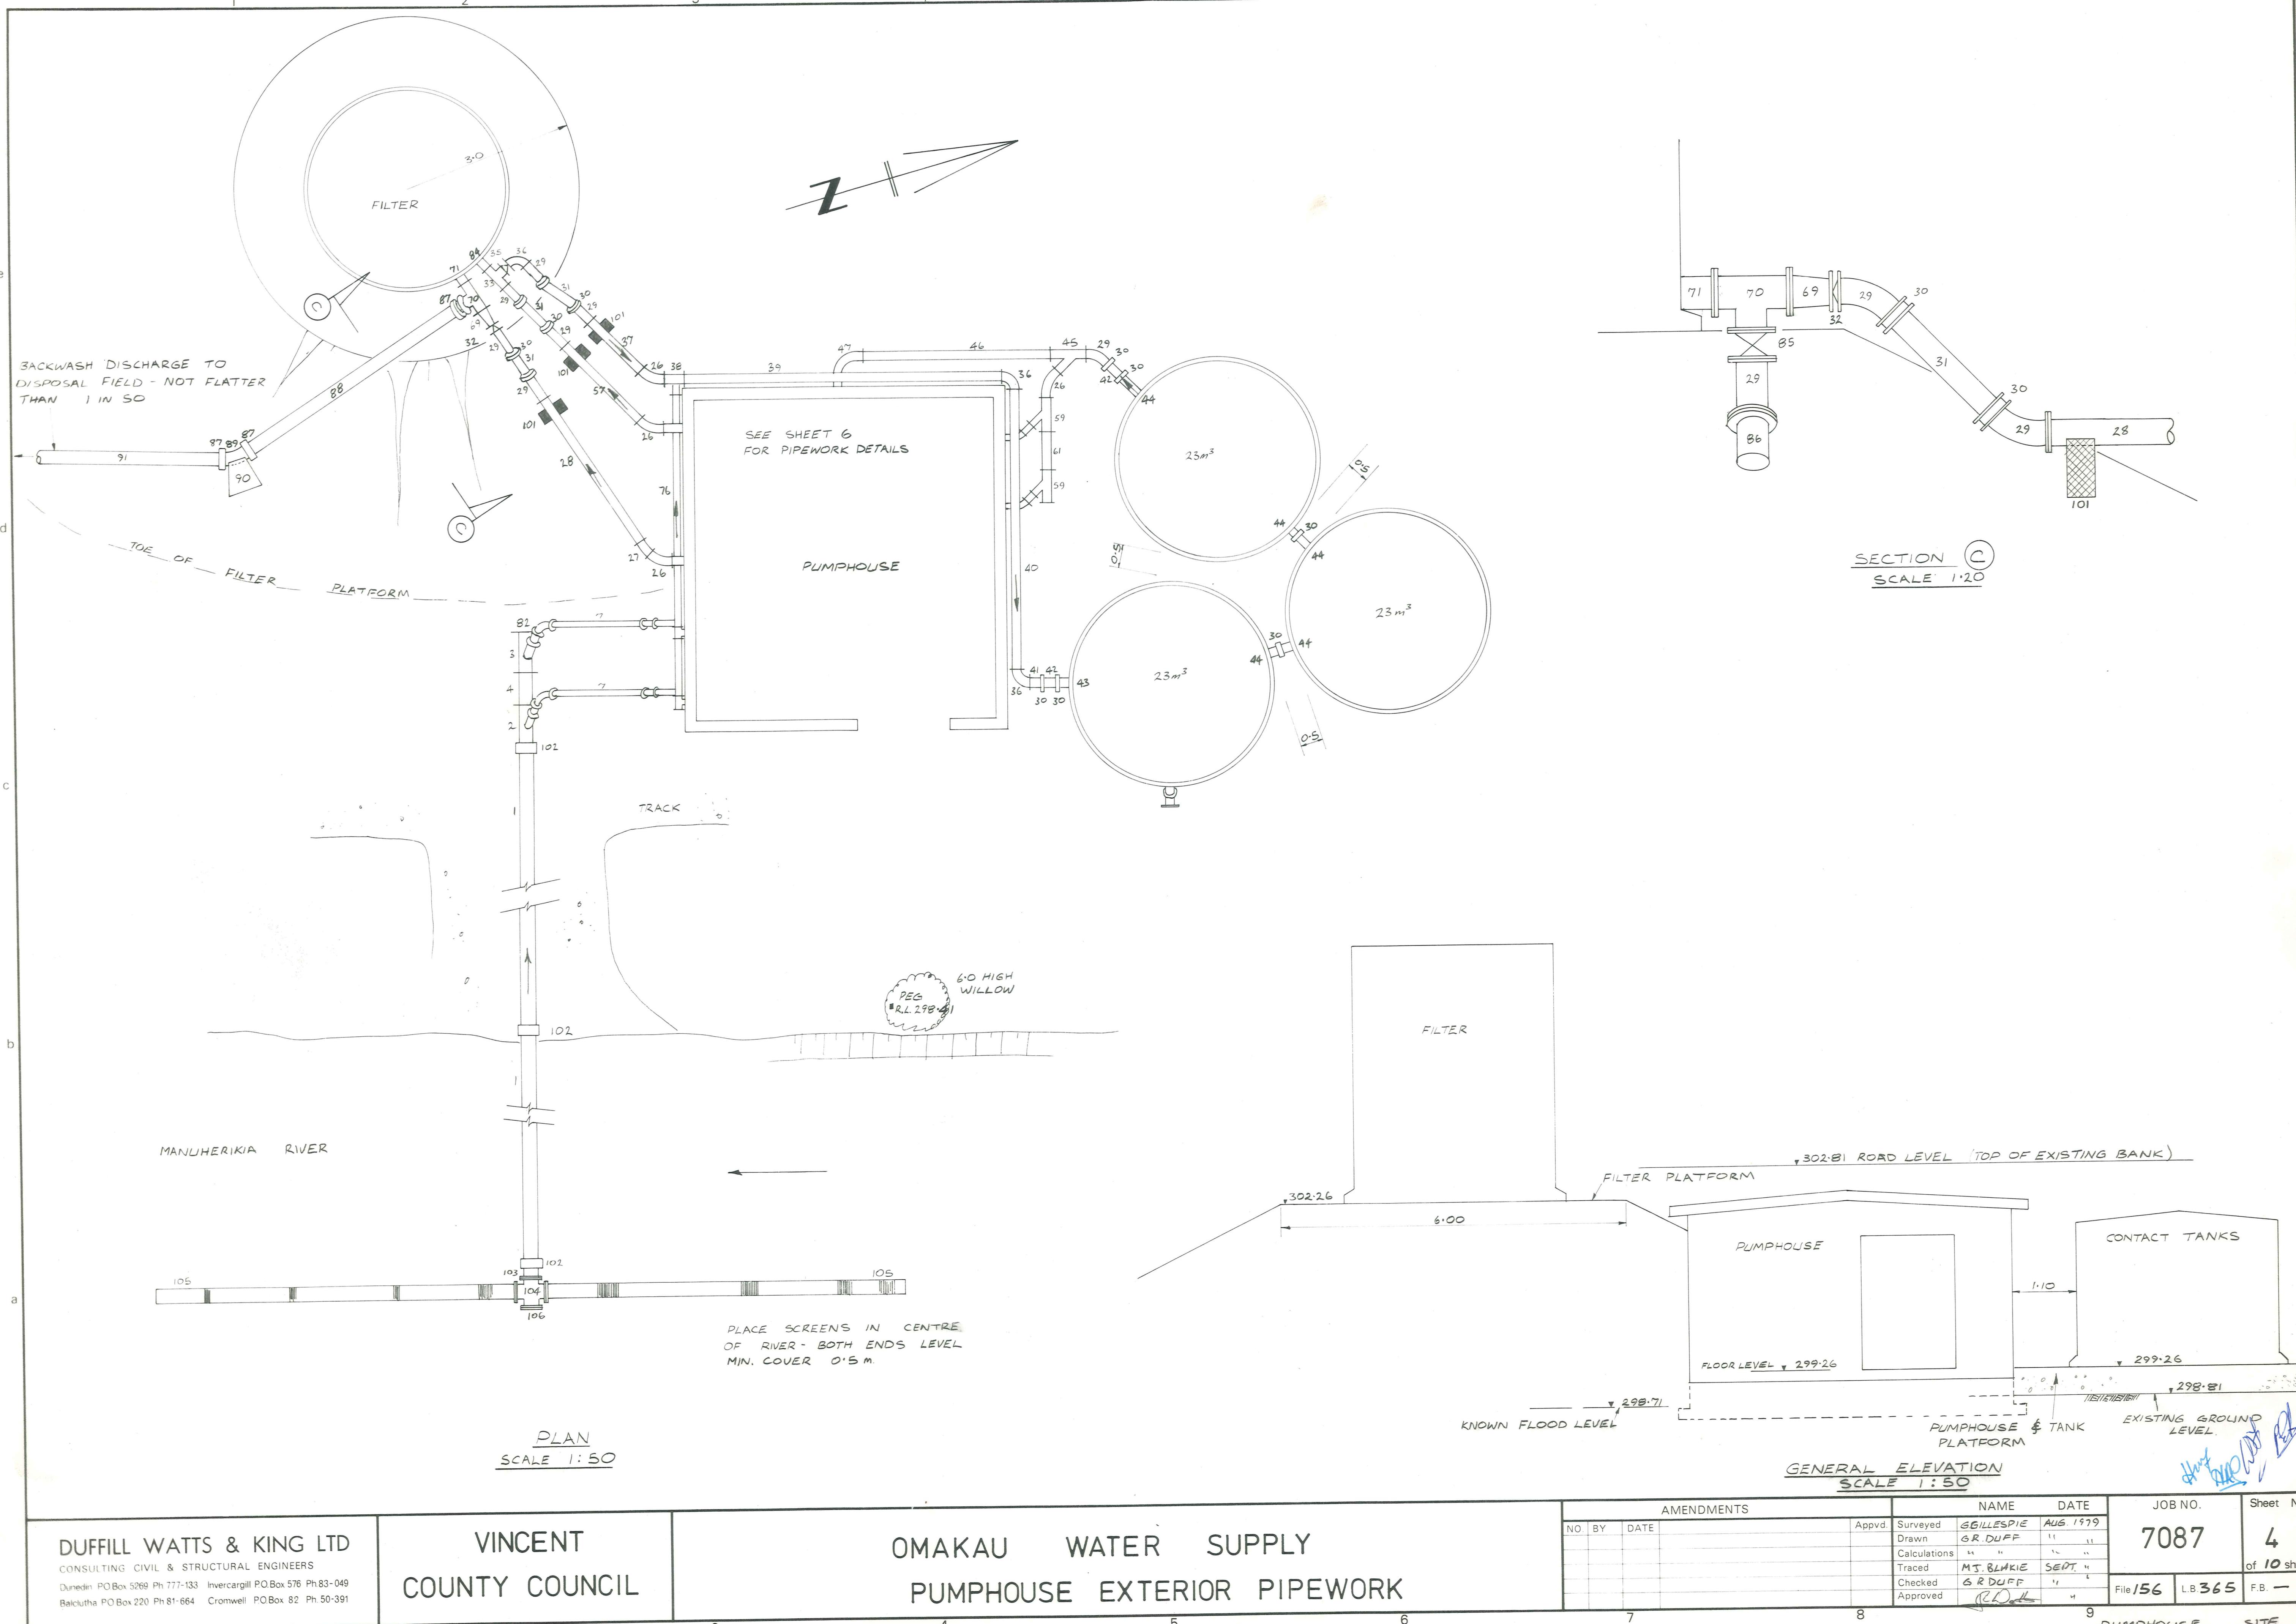

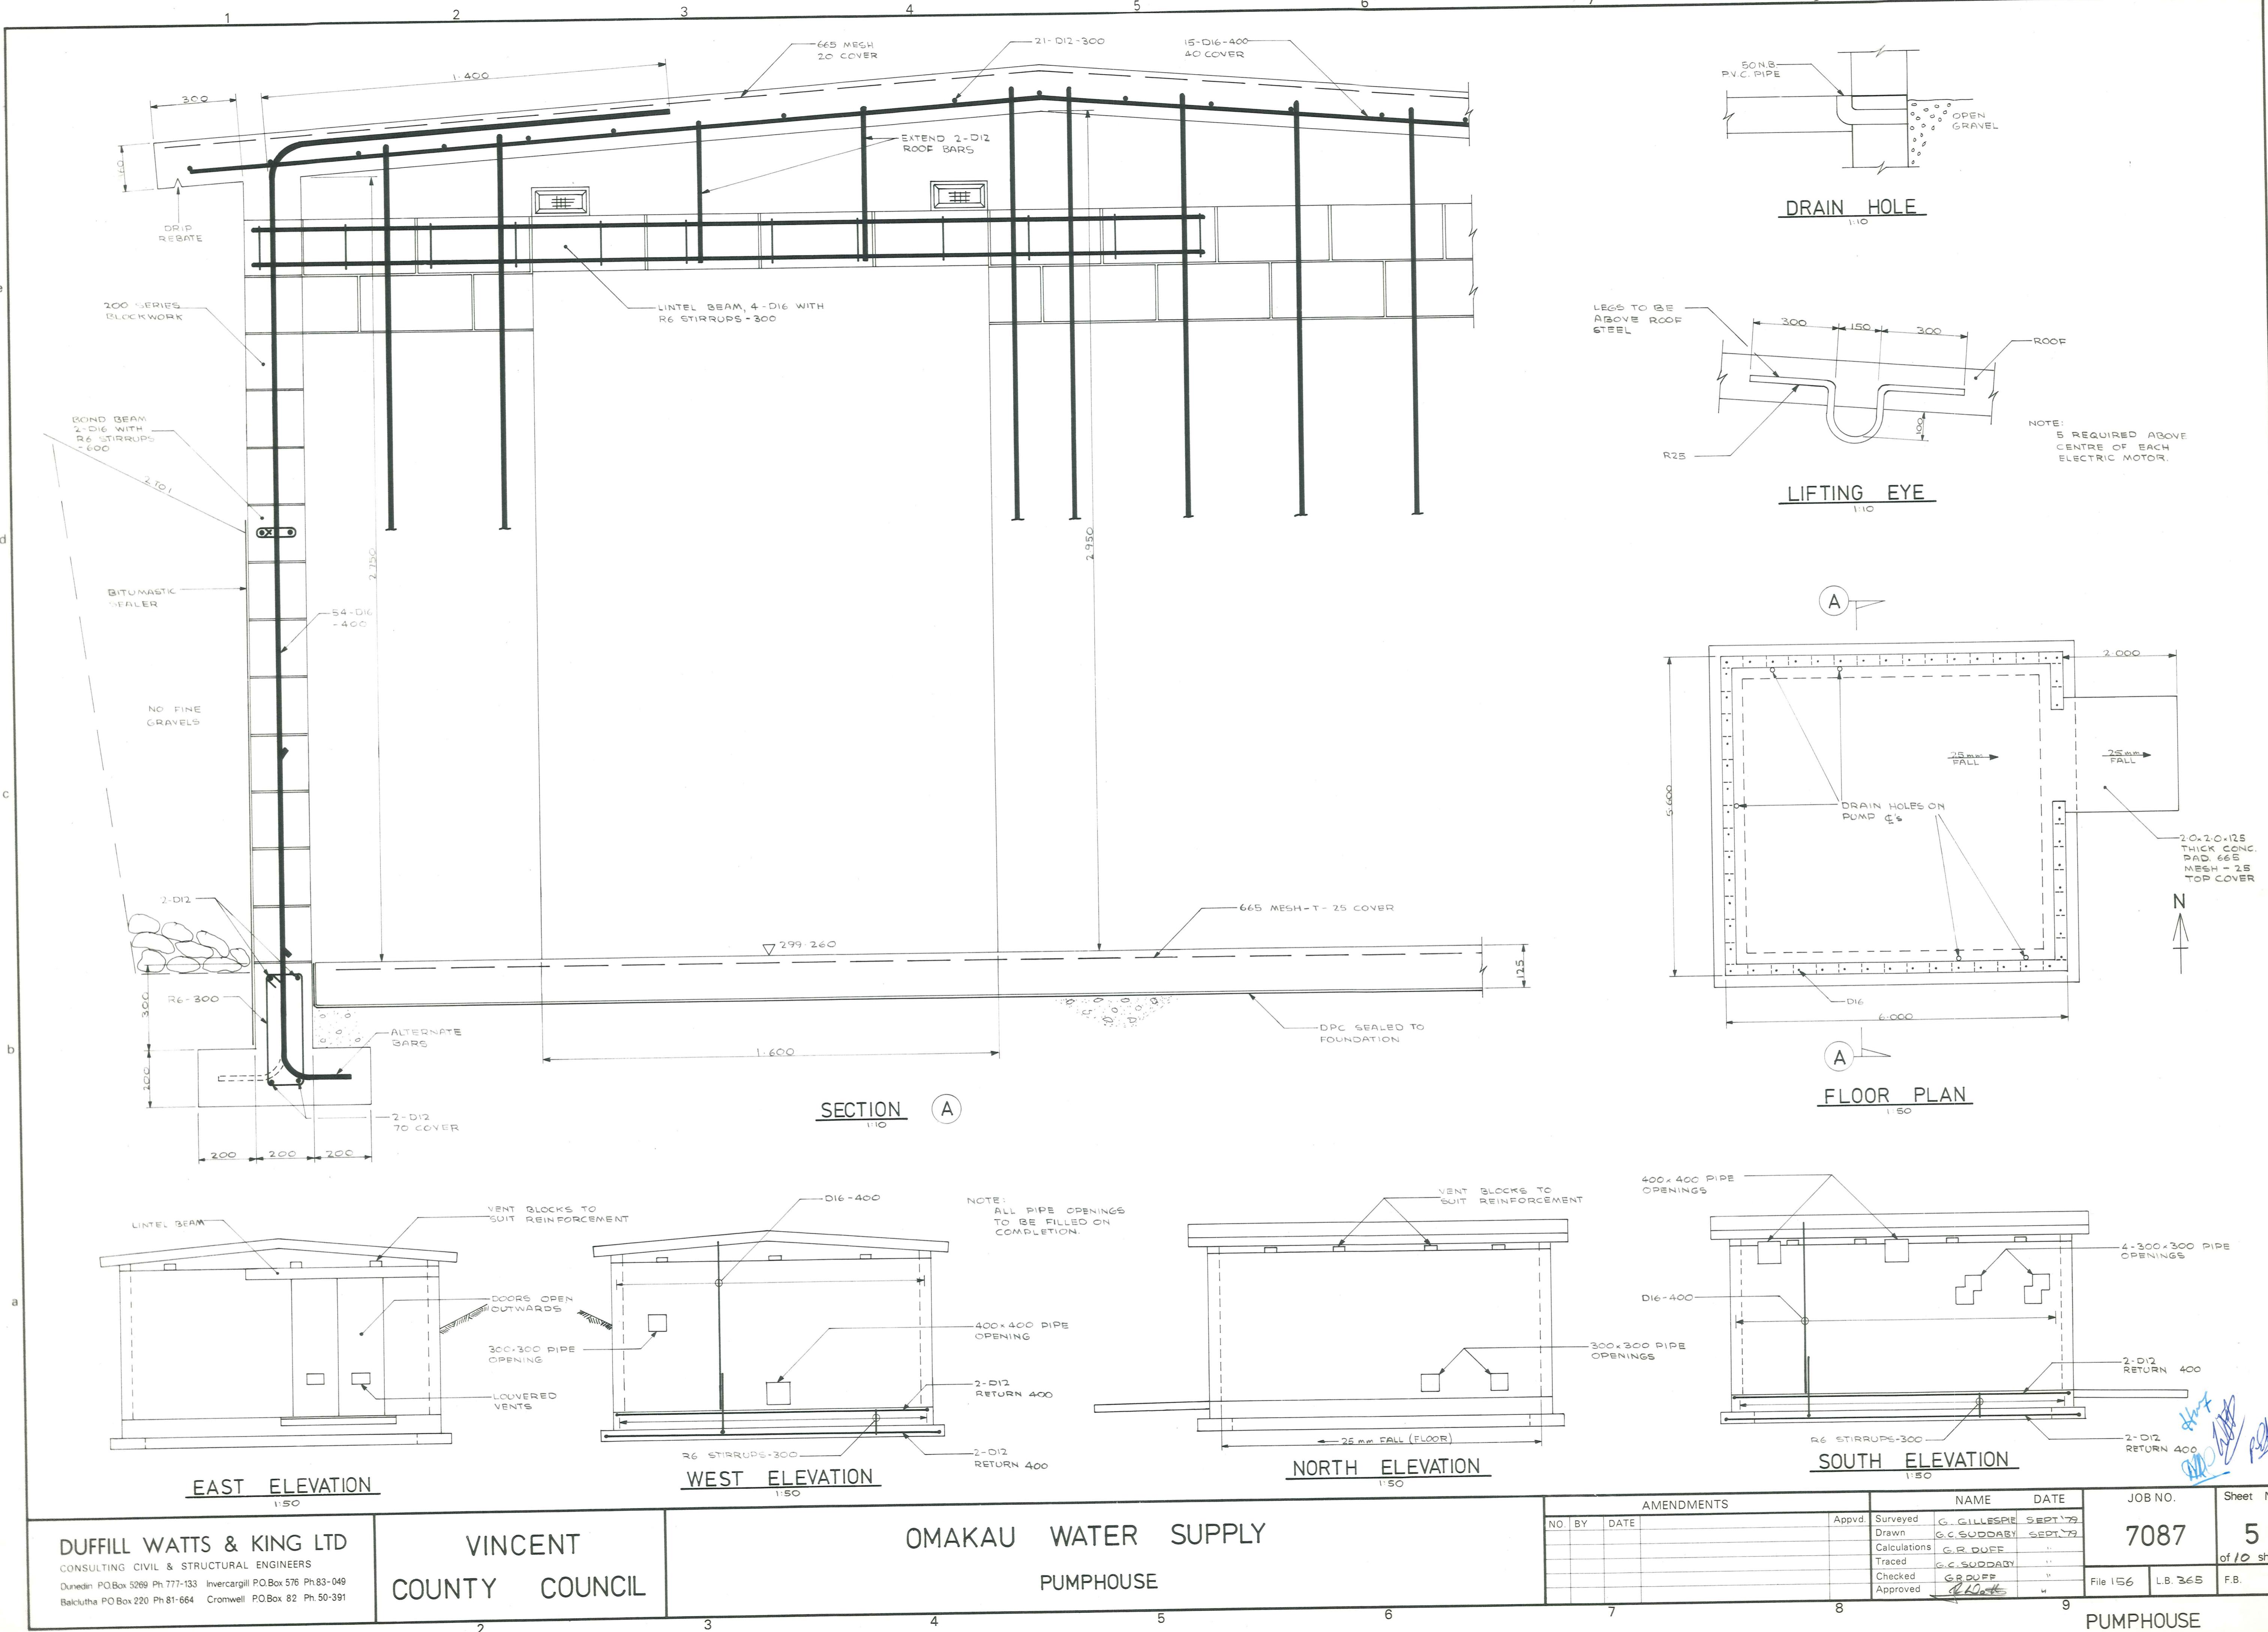

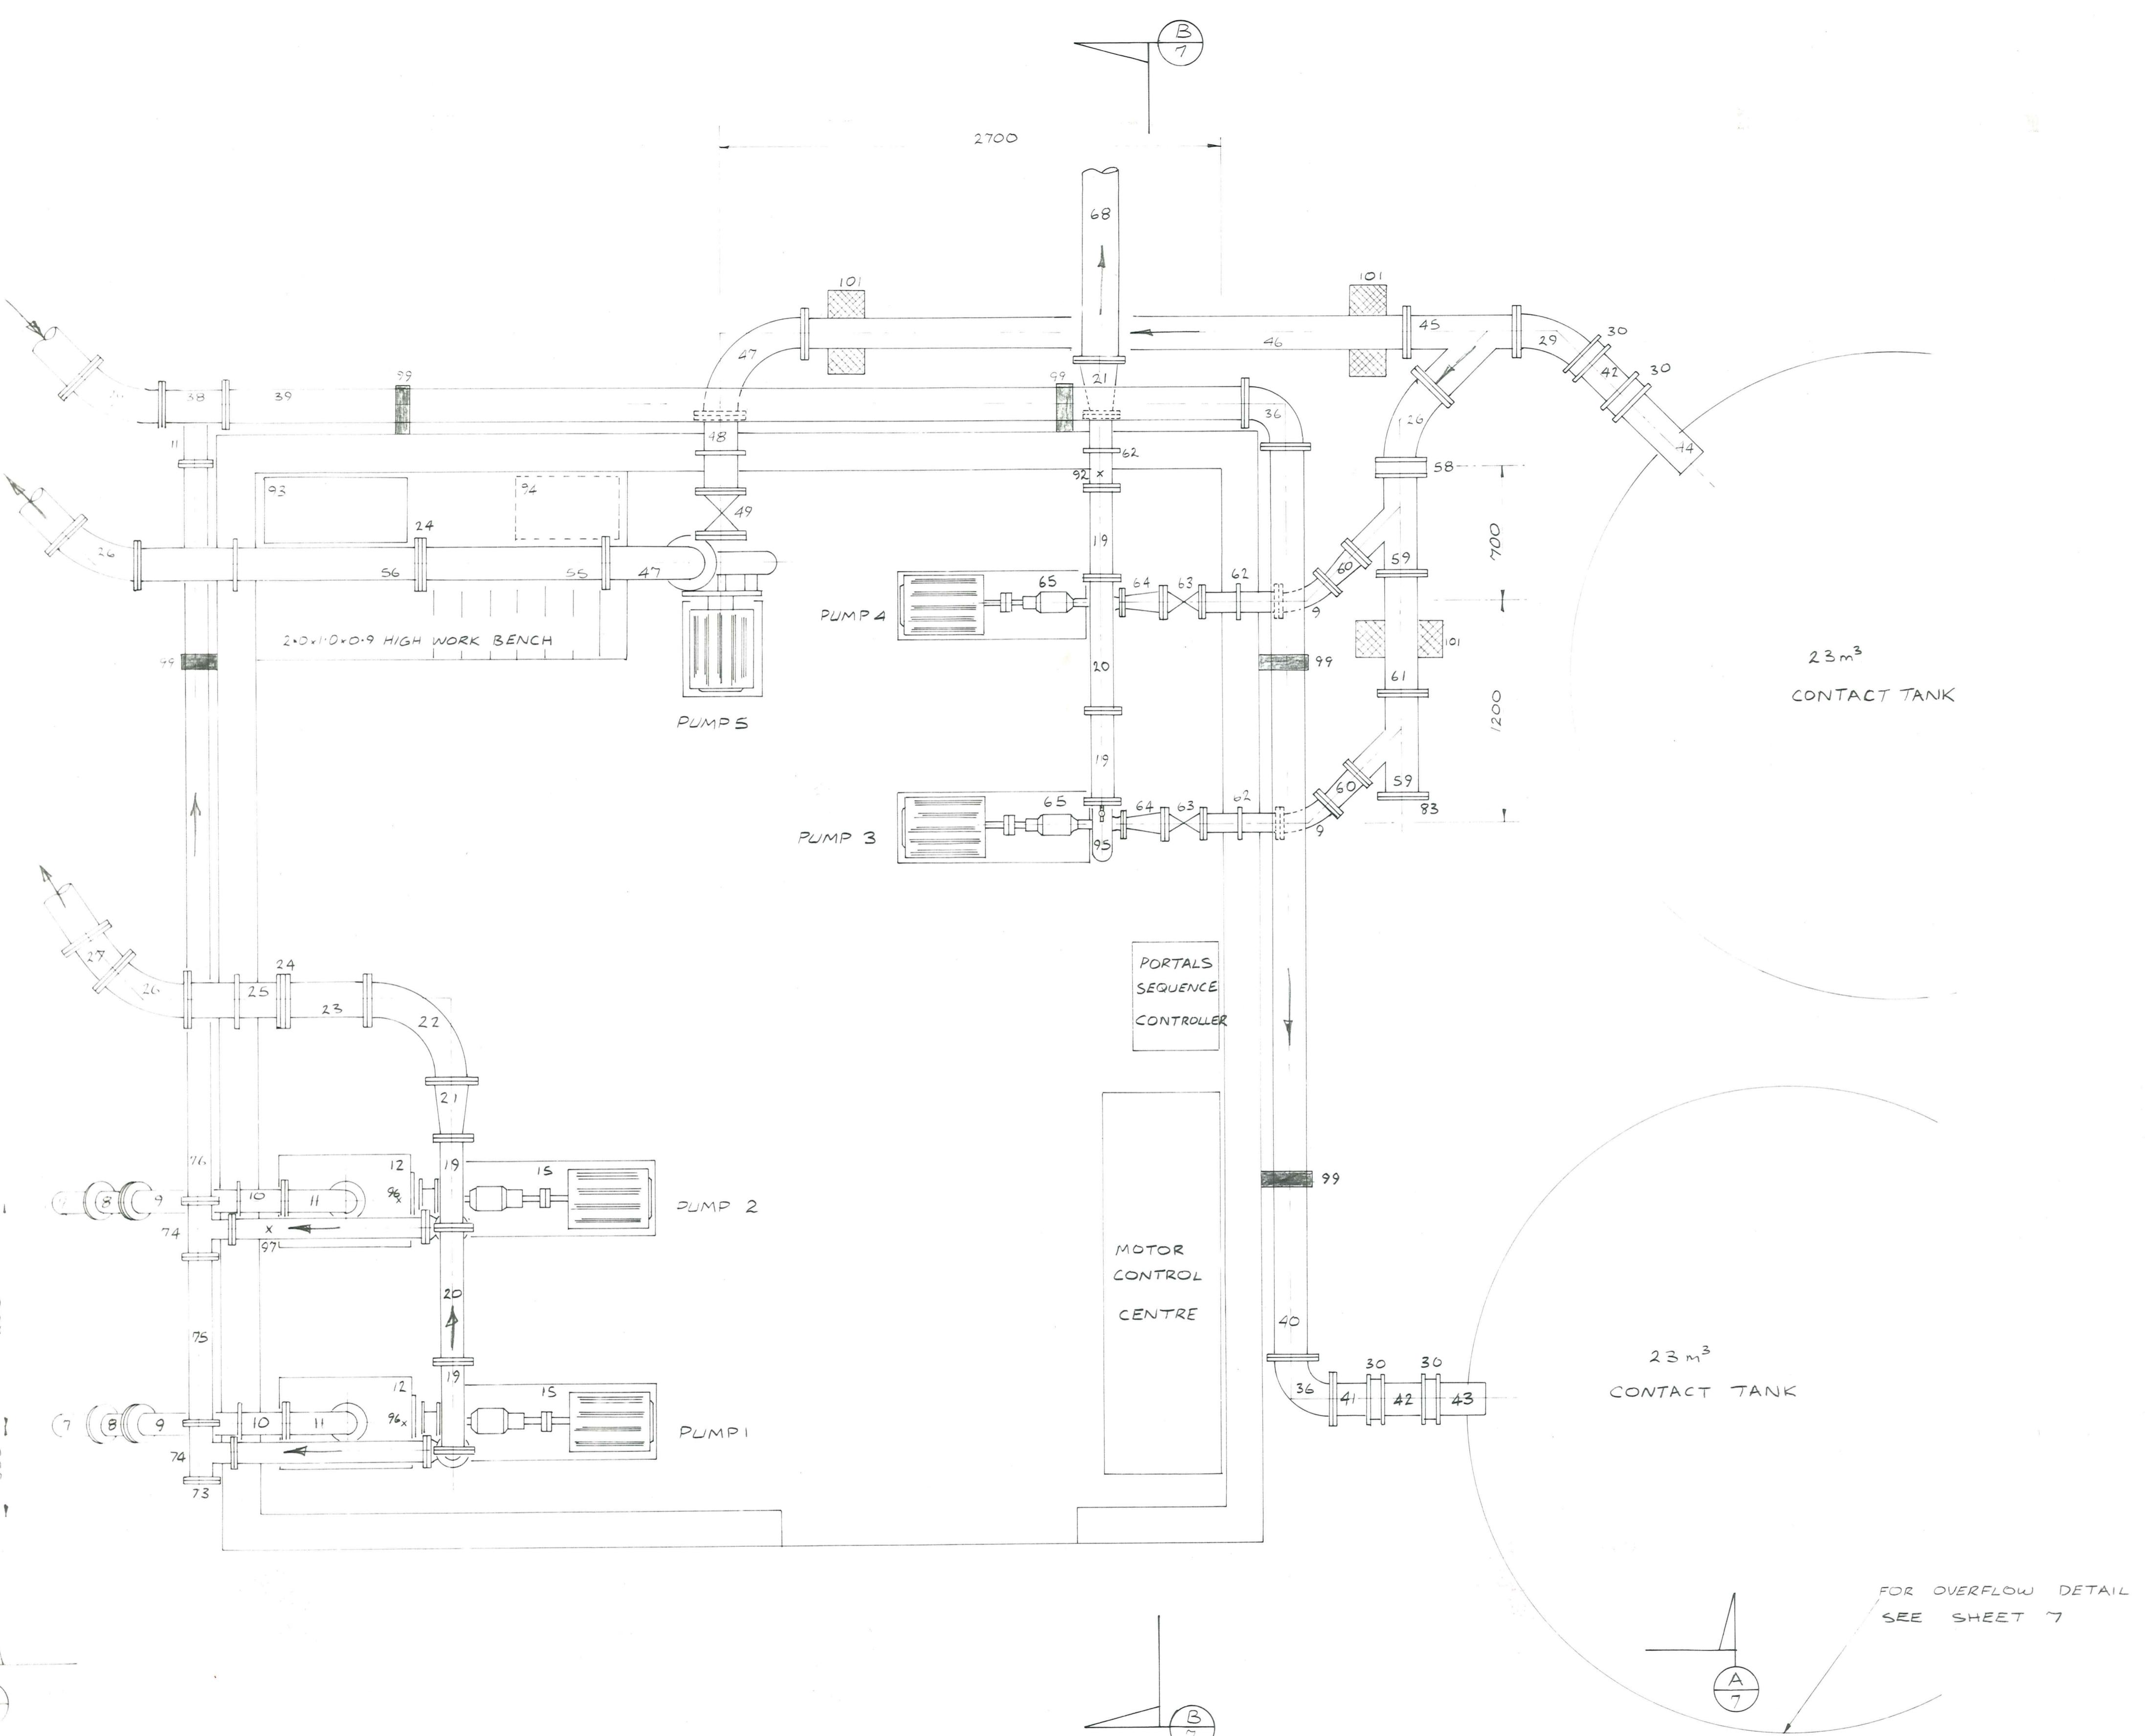

SCALE 1:20

FOR OVERFLOW DETAIL
SEE SHEET 7

DUFFILL WATTS & KING LTD
CONSULTING CIVIL & STRUCTURAL ENGINEERS
Level 1, 1000 Victoria St, PO Box 576, Ph 83-049
Baillie St, PO Box 220, Ph 81-664, Cromwell, PO Box 82, Ph 50-391


VINCENT
COUNTY COUNCIL


OMAKAU WATER SUPPLY
PUMPHOUSE PIPEWORK

CODE	
1.	225 mm A.C. stormwater pipe
2.	225 mm x 150 mm Y, 2 flanges only
3.	" " Y, 3 flanges
4.	225 mm x 506 mm long, straight D.F.
5.	150 mm x 100 mm reducer D.F.
6.	100 mm standard 45° bend D.F.
7.	100 mm x 4727 mm long straight D.F.
8.	100 mm standard 22½° bend, D.F.
9.	" " 45° bend, D.F.
10.	100 mm x 500 mm long straight D.F. plus puddle fl.
11.	100 mm standard 90° bend D.F.
12.	Priming vessel
13.	100 mm M & G. wafer swing check valve
14.	100 mm x 100 mm long straight D.F.
15.	Ajax 3L pump
16.	75 mm x 1220 mm long straight D.F.
17.	75 mm Serck Audeo 3-way T port valve (Fig MT11)
18.	75 mm standard 45° bend D.F.
19.	100 mm x 75 mm Y, 3 flanges
20.	100 mm x 724 mm long straight D.F.
21.	150 mm x 100 mm reducer D.F.
22.	150 mm standard 45° bend D.F.
23.	150 mm x 450 mm long straight D.F.
24.	Orifice plate
25.	150 mm x 500 mm long straight D.F. plus puddle fl.
26.	150 mm standard 45° bend D.F.
27.	" 11½° bend D.F.
28.	150 mm x 3100 mm long straight D.F.
29.	150 mm standard 45° bend 1 fl. only
30.	150 mm gibault joint
31.	150 mm x 950 mm long straight P.E.
32.	150 mm M & G. wafer swing check valve
33.	150 mm x 150 mm tee, 3 flanges
34.	150 mm washout valve
35.	150 mm filter outlet valve
36.	150 mm short radius 90° bend D.F.
37.	150 mm x 100 mm Tee 3 flanges
38.	150 mm x 5489 mm long straight D.F.
39.	150 mm x 4900 mm long straight D.F.
40.	150 mm x 225 mm long flange adaptor
41.	150 mm x 320 mm long straight P.E.
42.	150 mm x 300 mm long straight P.E.
43.	150 mm x 500 mm long straight P.E.
44.	150 mm x 150 mm long straight P.E.
45.	150 mm x 150 mm Y, 3 flanges
46.	150 mm x 3260 mm long straight D.F.
47.	150 mm standard 90° bend D.F.
48.	150 mm x 400 mm long straight D.F. plus puddle fl.
49.	150 mm valve, Blakeborough Fig. 2323
50.	Davies K15 B pump
51.	150 mm x 125 mm reducer D.F.
52.	150 mm M & G. wafer swing check valve
53.	150 mm x 1260 mm long straight D.F.
54.	150 mm Serck Audeo butterfly valve
55.	150 mm x 1000 mm long straight D.F.
56.	150 mm x 1500 mm long straight D.F. plus puddle fl.
57.	150 mm x 1850 mm long straight D.F.
58.	150 mm x 60 mm long spacer
59.	150 mm x 100 mm Y, 3 flanges
60.	100 mm x 75 mm reducer D.F.
61.	150 mm x 656 mm long straight D.F.
62.	100 mm x 400 mm long straight D.F. plus puddle fl.
63.	100 mm valve Blakeborough Fig. 2323
64.	100 mm x 65 mm reducer D.F.
65.	Ajax 2L pump
66.	75 mm x 50 mm reducer D.F.
67.	75 mm APCO series 000 check valve Model 053
68.	150 mm x 6000 mm long straight one fl. only plus puddle fl.
69.	200 mm x 150 mm reducer D.F.
70.	200 mm x 200 mm Tee 3 flanges
71.	200 mm filter washout
72.	75 mm x 1030 mm long straight D.F.
73.	100 mm blank flange
74.	100 mm x 75 mm Tee 3 flanges
75.	100 mm x 894 long straight D.F.
76.	100 mm x 3980 mm long straight D.F.
77.	100 mm x 100 mm long straight D.F.
78.	150 mm sluice valve and box
79.	150 mm hydrant Tee P.E.
80.	Streamline hydrant, riser and box
81.	150 mm Class D A.C. pipe
82.	225 mm blank flange
83.	150 mm " "
84.	150 mm filter outlet
85.	200 mm washout valve
86.	200 mm flange adaptor
87.	200 mm gibault joint
88.	200 mm x 6000 mm long A.C. stormwater pipe
89.	200 mm standard 45° bend P.E.
90.	Conc. anchor block 0.5 m x 0.5 m x 0.5 m
91.	200 mm x 20.0 m A.C. stormwater pipe
92.	150 mm pressure gauge (0-1000 kPa) plus gauge cock
93.	Chlorine equipment on work bench
94.	Compressor under work bench
95.	12 mm hose tap plus 10 m rubber hose
96.	63 mm vacuum gauge (-100 - 0 kPa)
97.	12 mm gate-valve (drain) under pipe with hose through wall
98.	Type A support
99.	" B "
100.	" C "
101.	" D "
102.	225 mm Supertite coupling
103.	225 mm flange adaptor
104.	225 mm x 225 mm cross 4 flanges
105.	250 mm x 0200 mm Johnson irrigator screen one fl., one blanked-off end
106.	225 mm blank flange - 2 bolts only
107.	150 mm x 1700 mm long straight D.F.
108.	Galv. strap ex 50 mm x 6 mm plate
	Gillies dimensions used throughout, other Foundries acceptable, but some spacers could be required.
	All flanges table D.
	Pipes can be C.I. med. galv. steel or bitumen lined steel
	Denotes supplied and installed by Portals


AMENDMENTS		NAME	DATE	JOB NO.	Sheet No
NO	BY	DATE			
Appvd.	Surveyed	G.GILLESPIE	AUG 1979		
	Drawn	GR DUFF	"		
	Calculations	"	"		
Traced	"	M.SBLACKIE	SEPT "		
Checked	"	GR DUFF	"		
Approved	"	R.JOHNSON	"		
				7087	6
					of 10 shts
				File 156	L.B 365
				F.B. —	

PUMPHOUSE PIPES

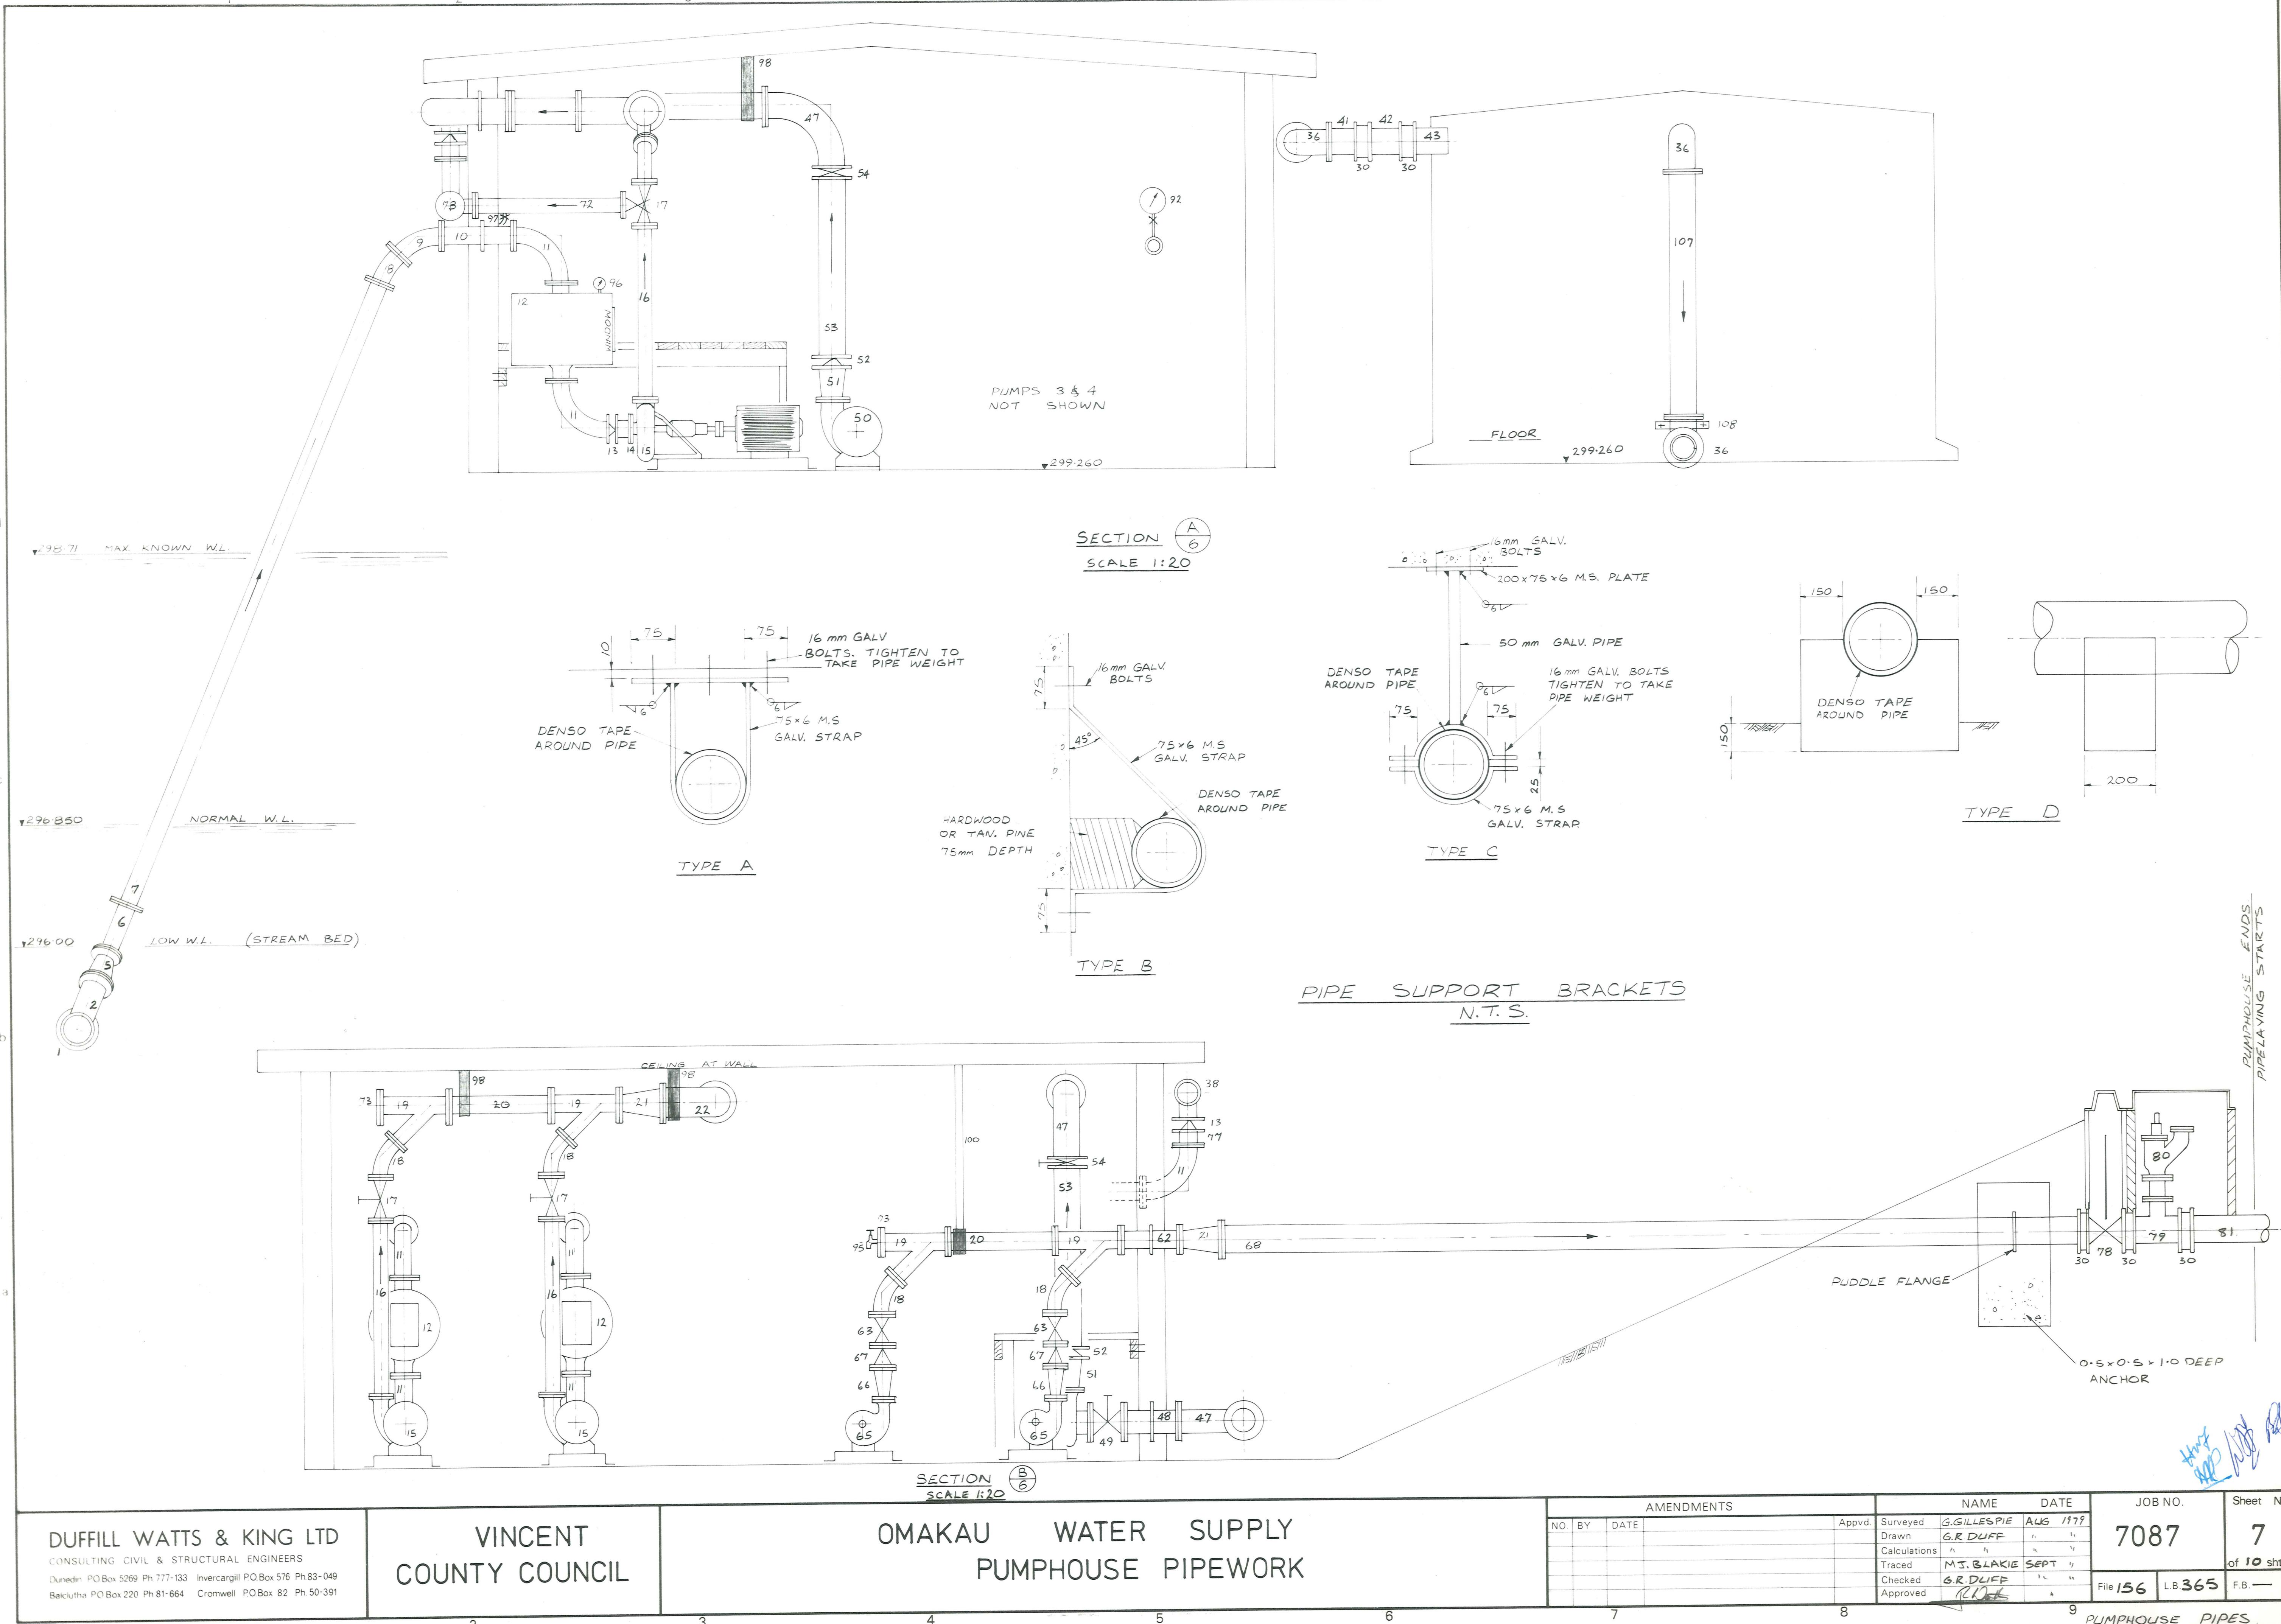


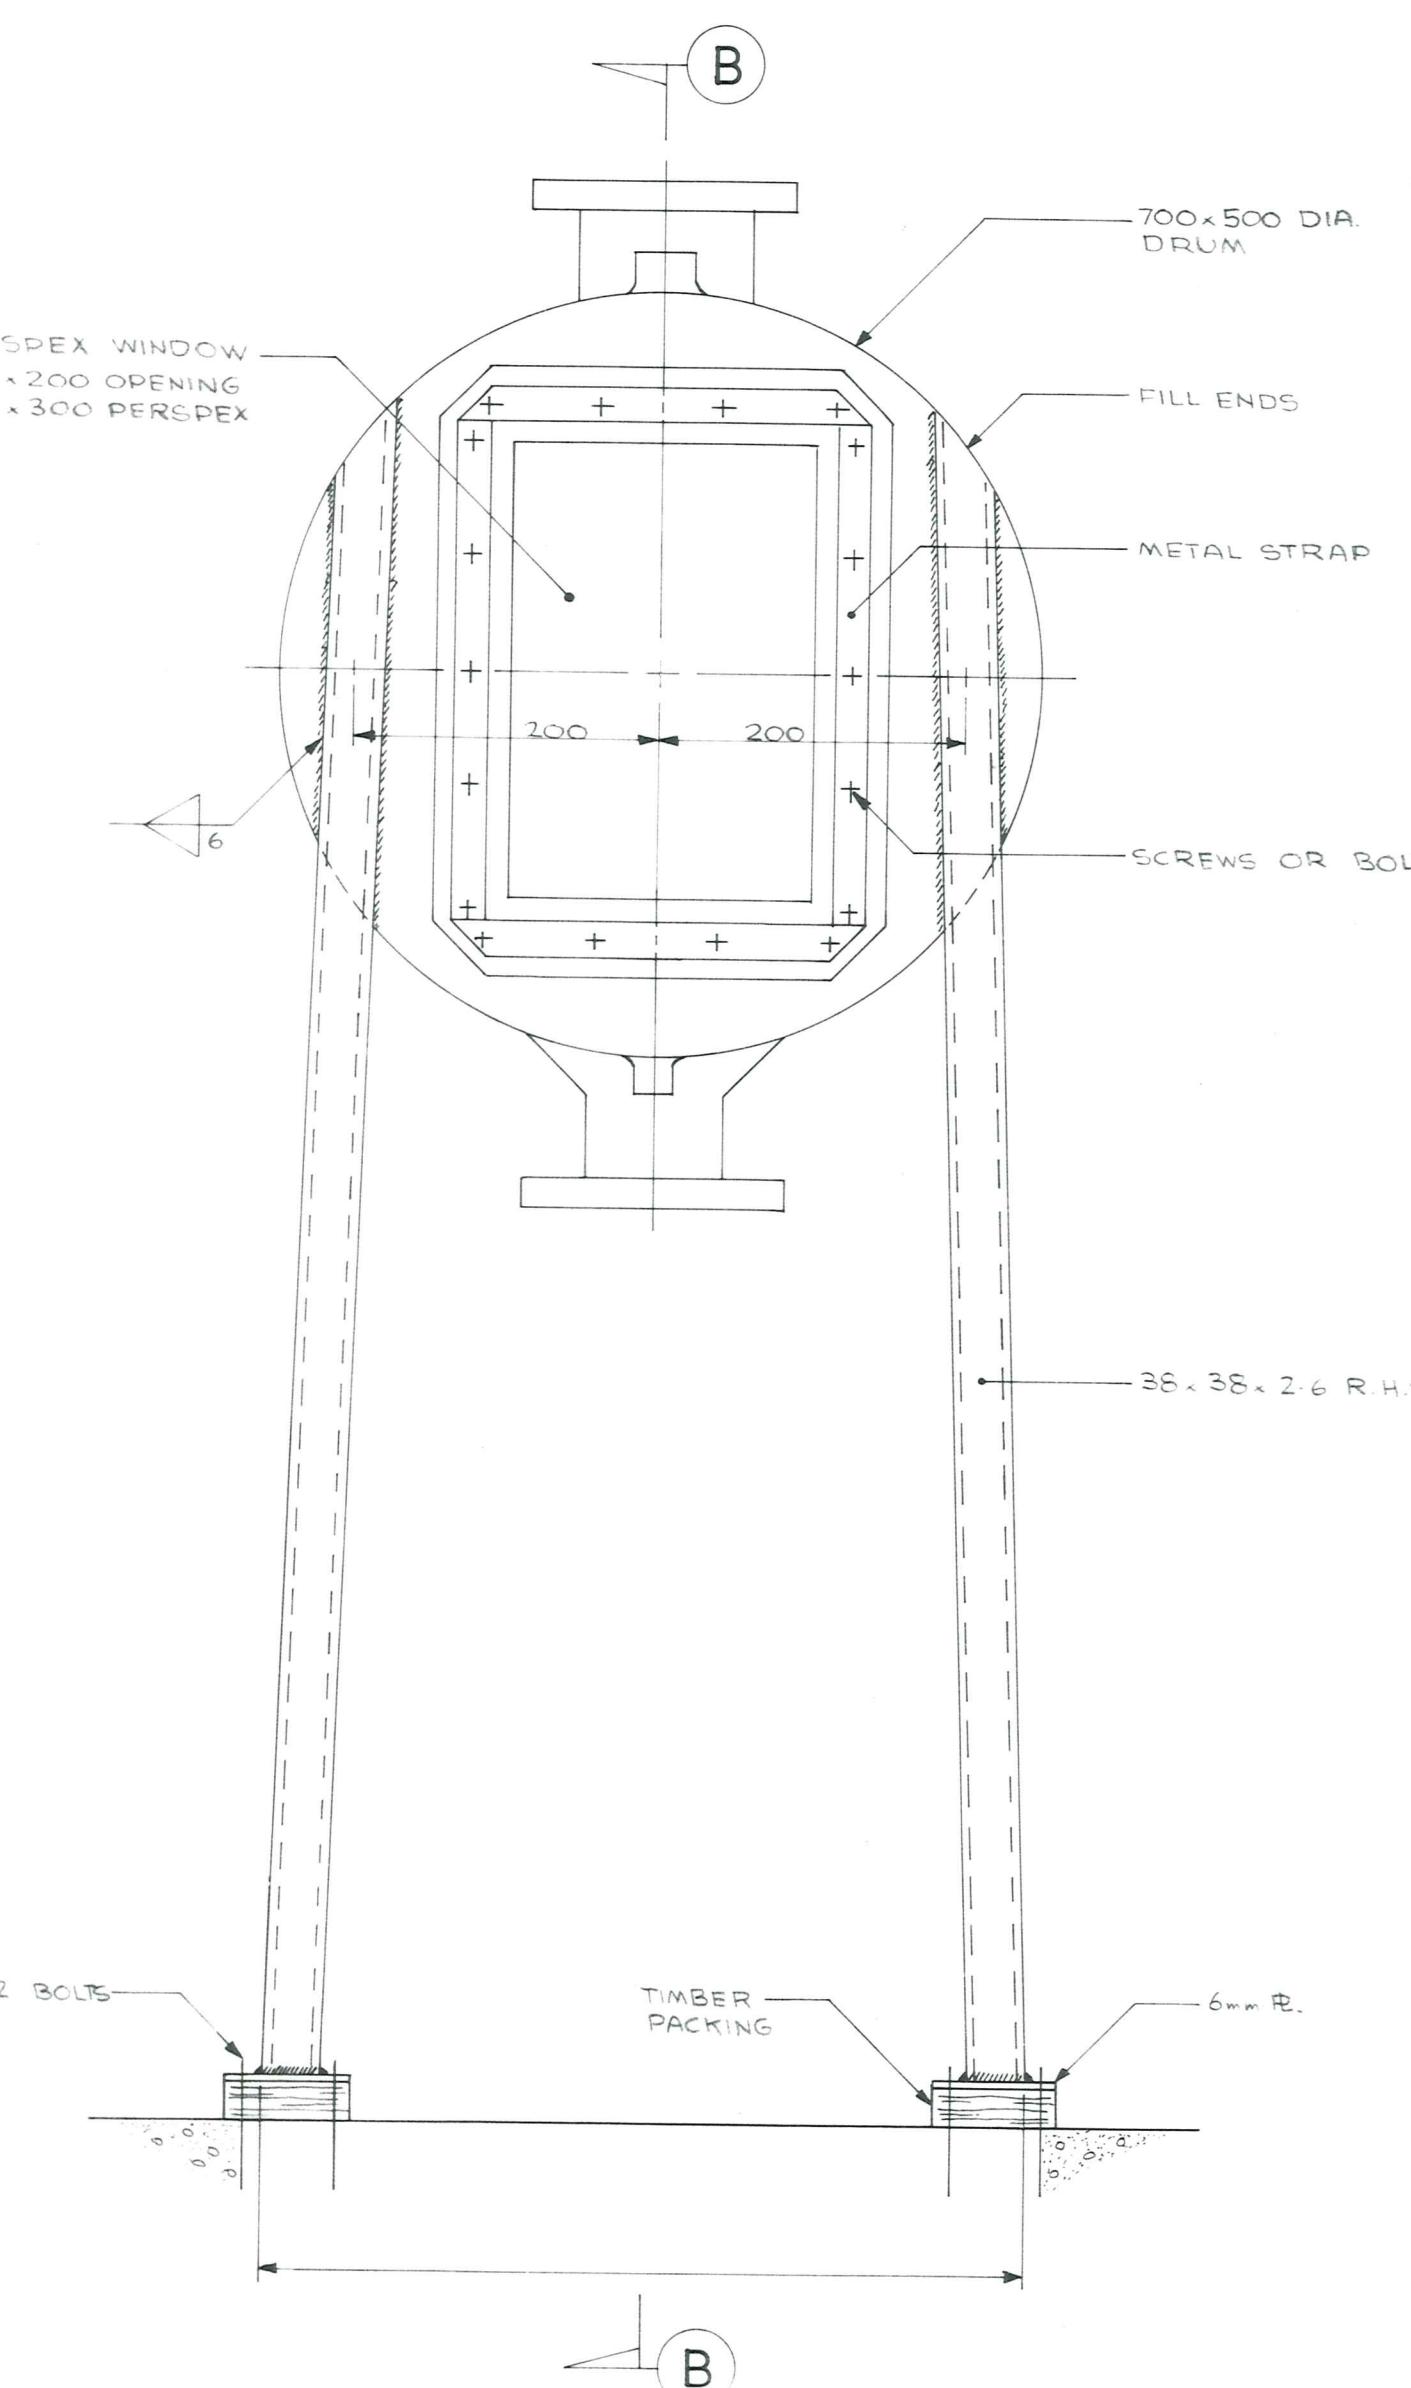

FRONT ELEVATION

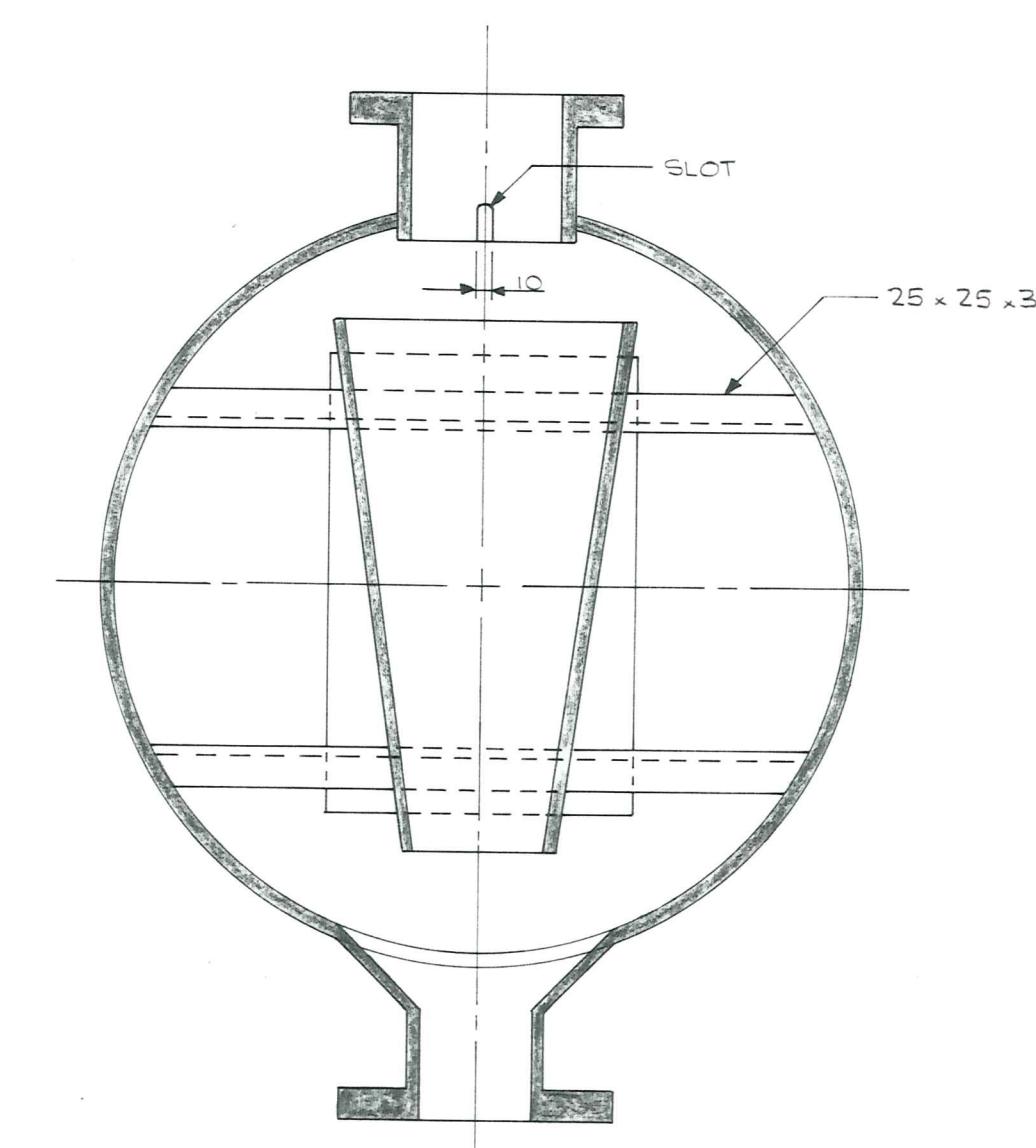

SECTION A

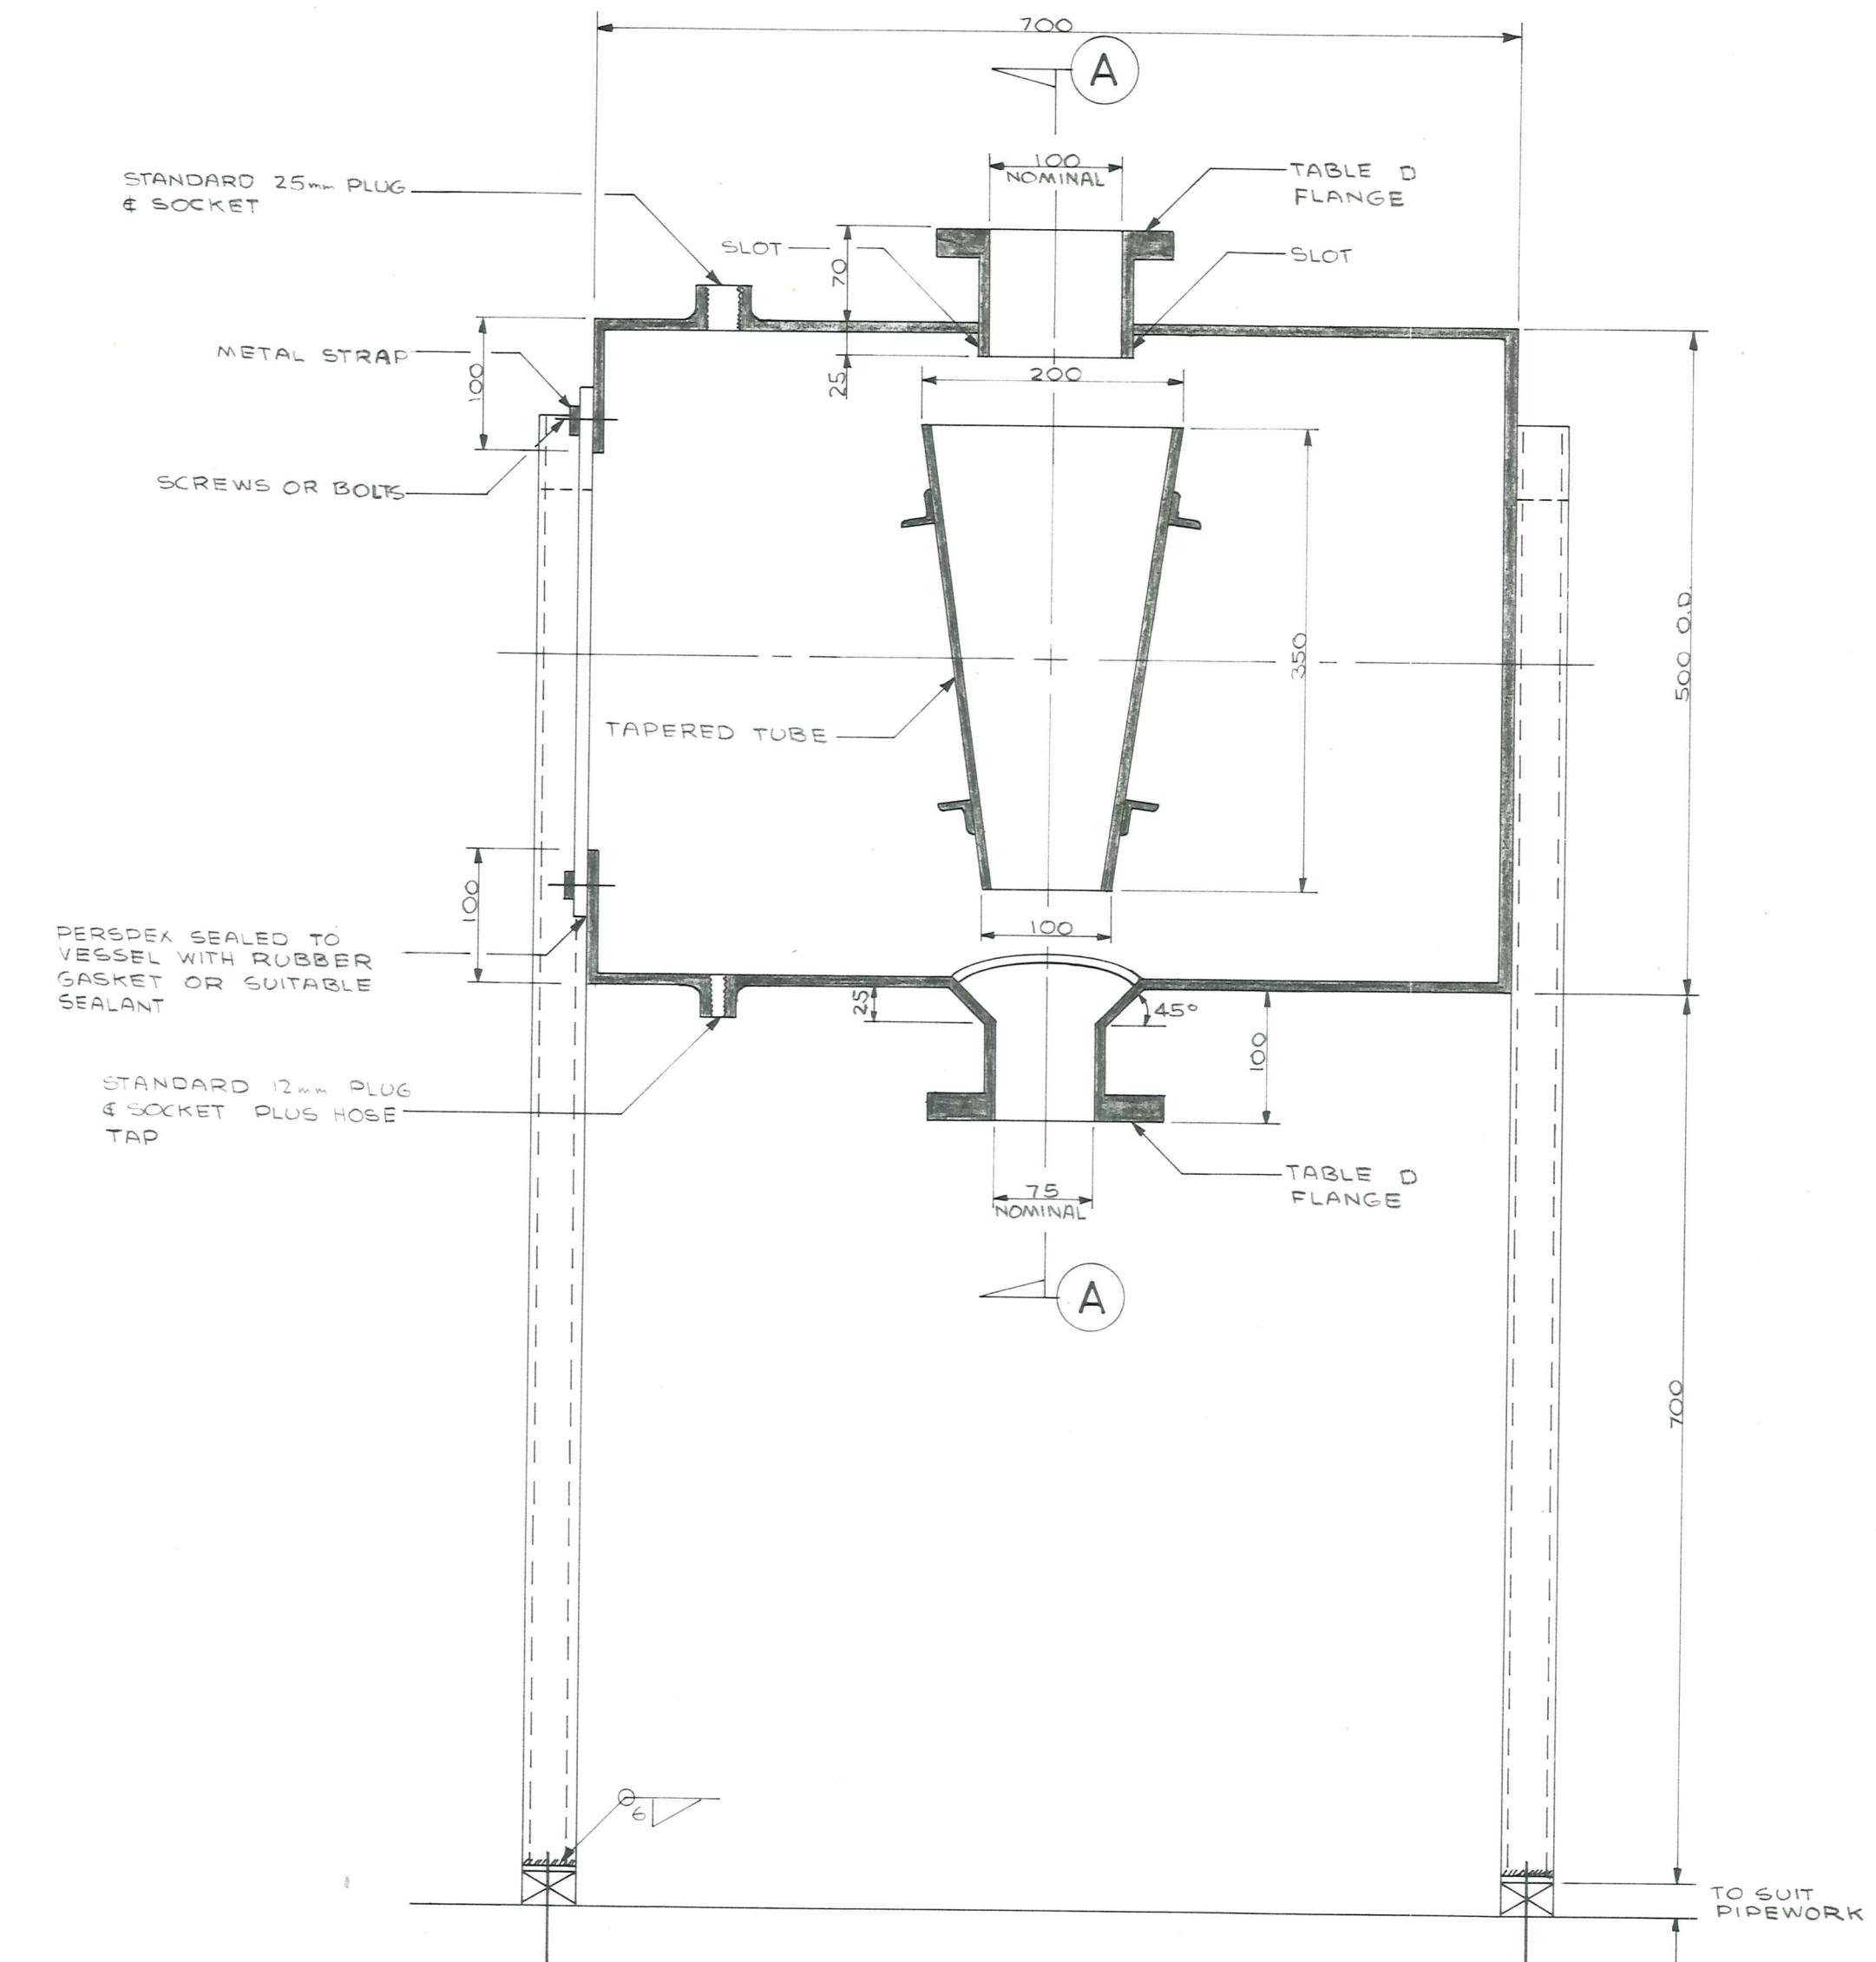


SECTION B


SPECIFICATIONS


MATERIALS - 700x500 DIA CYLINDER - MILD STEEL, MIN 3.18mm THICK
 850 TAPERED TUBE
 FLANGE NECKS
 TAPERED TUBE SUPPORTS
 WINDOW STRIPS
 SCREWS & BOLTS
 WINDOW LEGS
 - STAINLESS STEEL
 - 10mm PERSPEX
 - MILD STEEL, 38x38x2.6 RHS.


PAINTING - EXTERIOR SURFACES
 INTERIOR SURFACES - 2 COATS INTERZINC
 - 2 COATS INTERZINC
 PLUS FINAL WHITE ENAMEL


TESTING - PRIMING VESSEL MUST WITHSTAND 70% VACUUM. (-70 kPa)

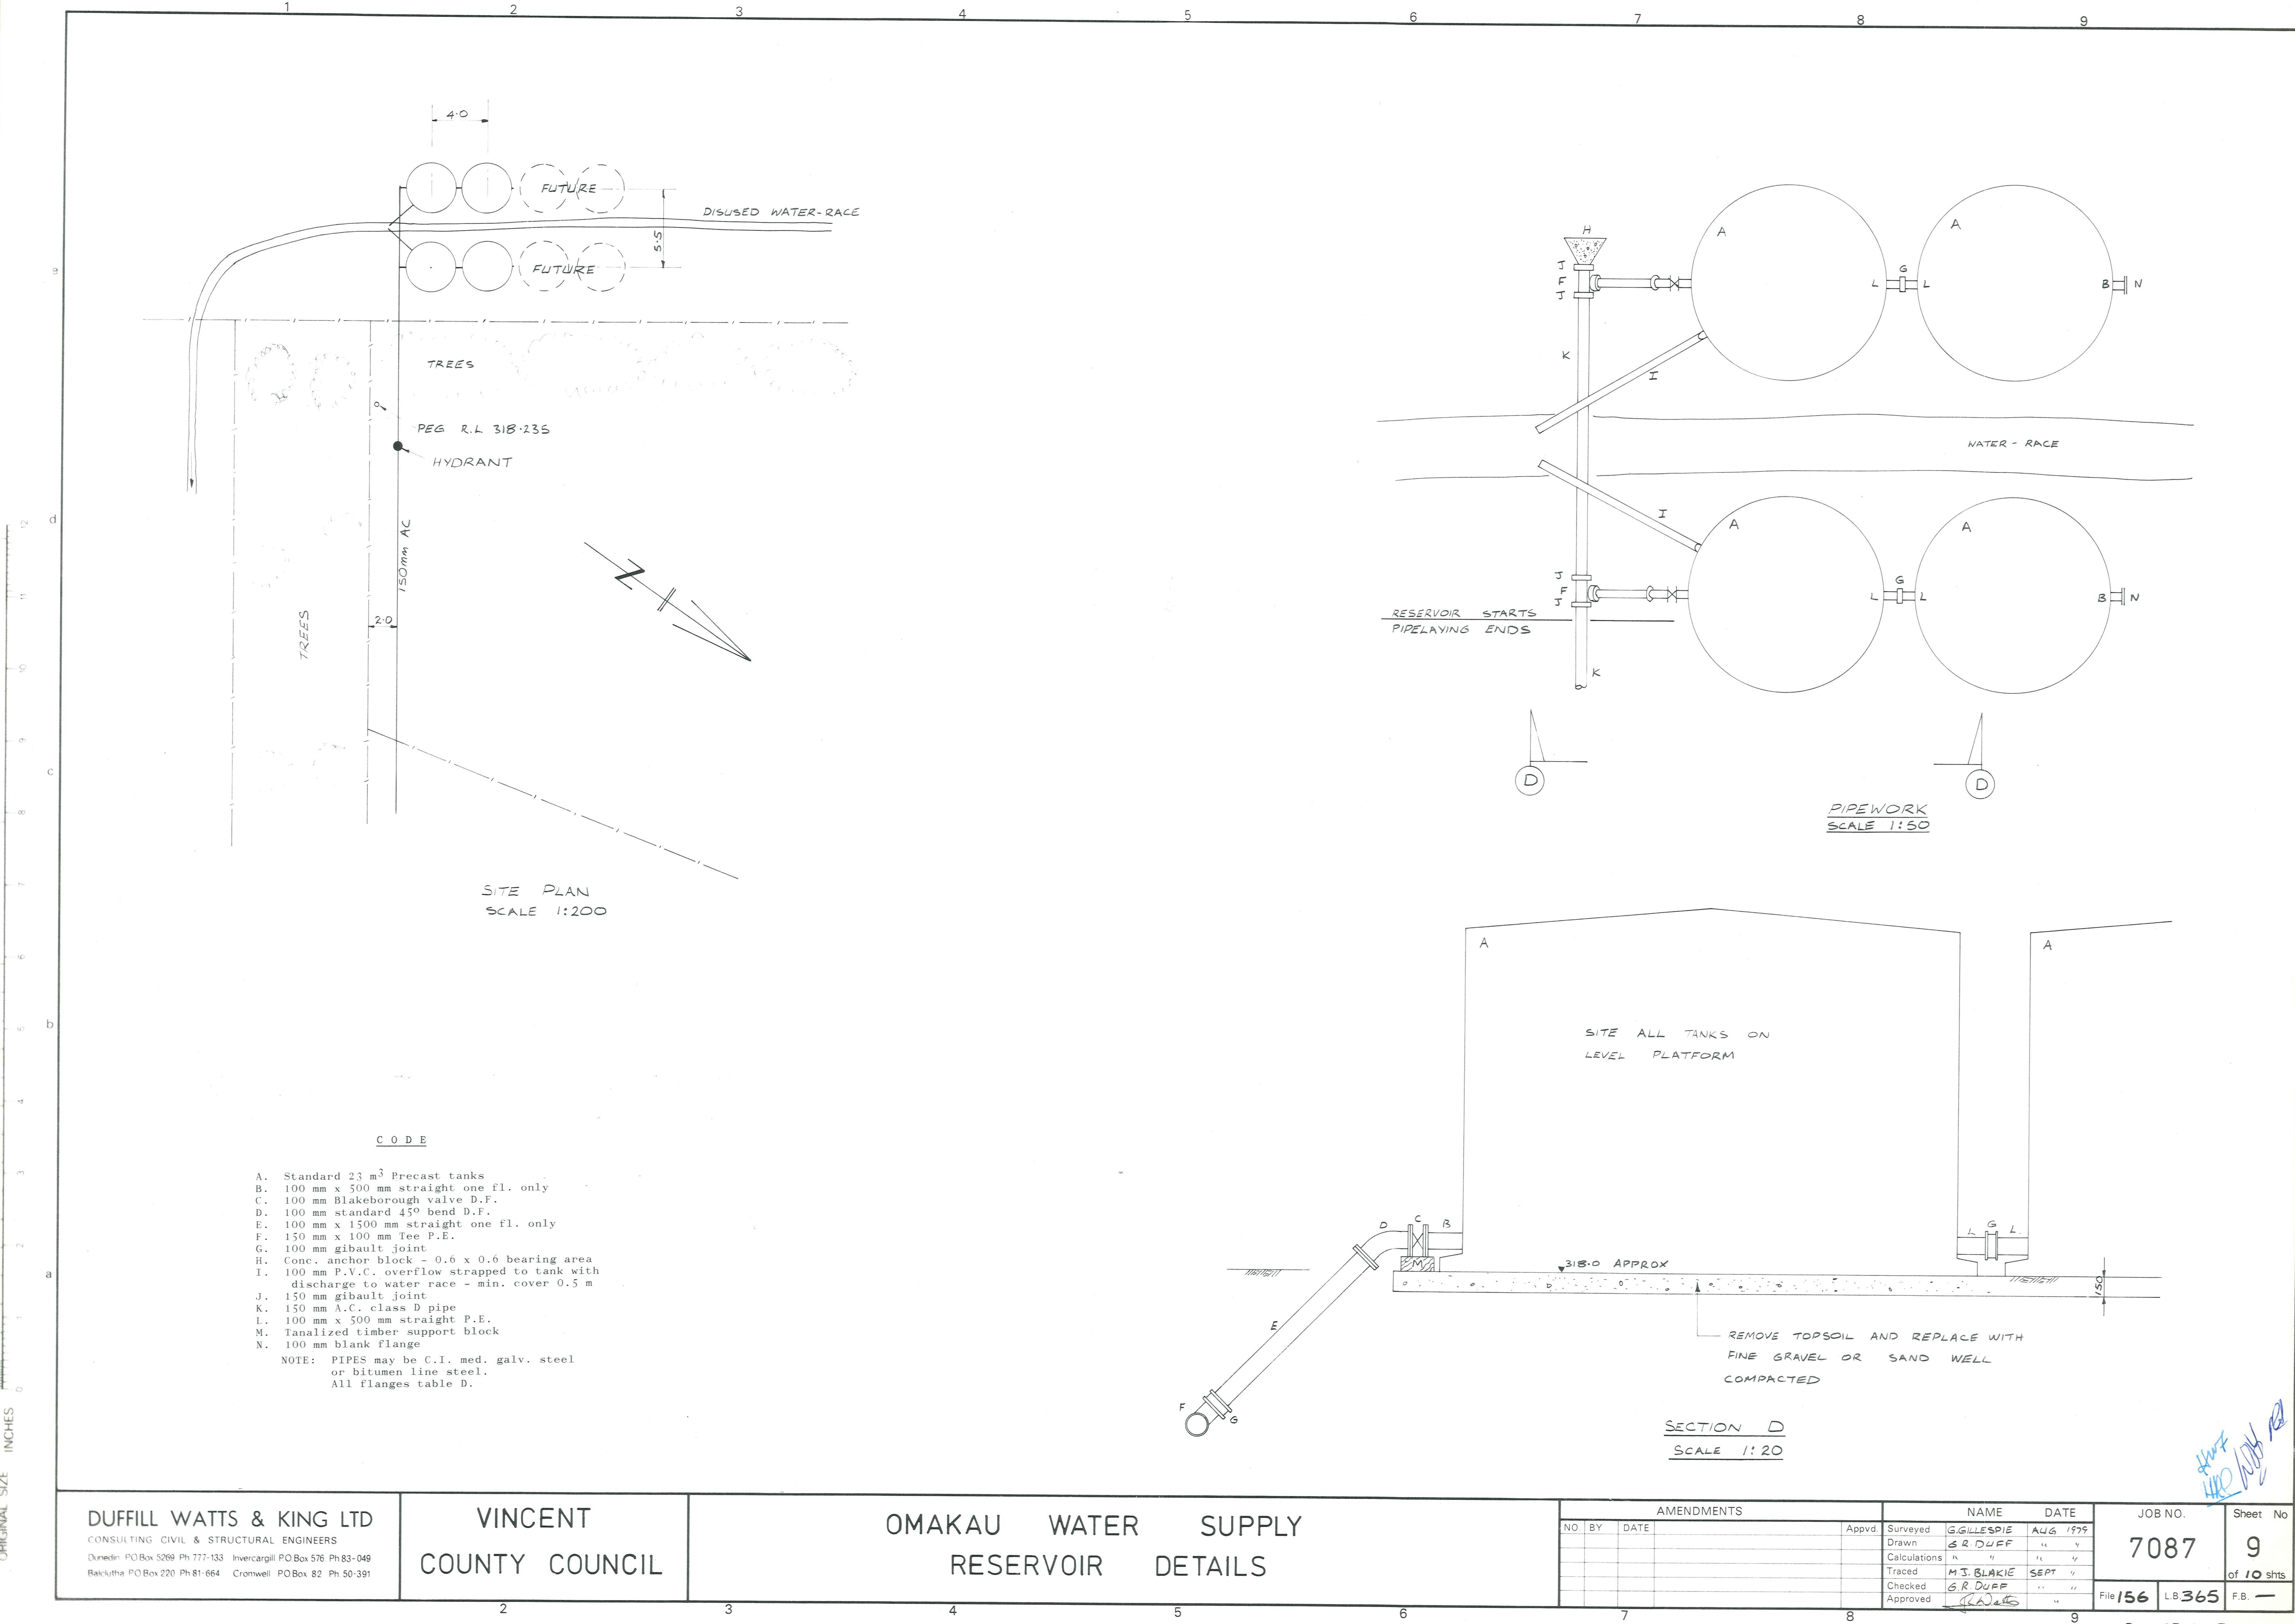


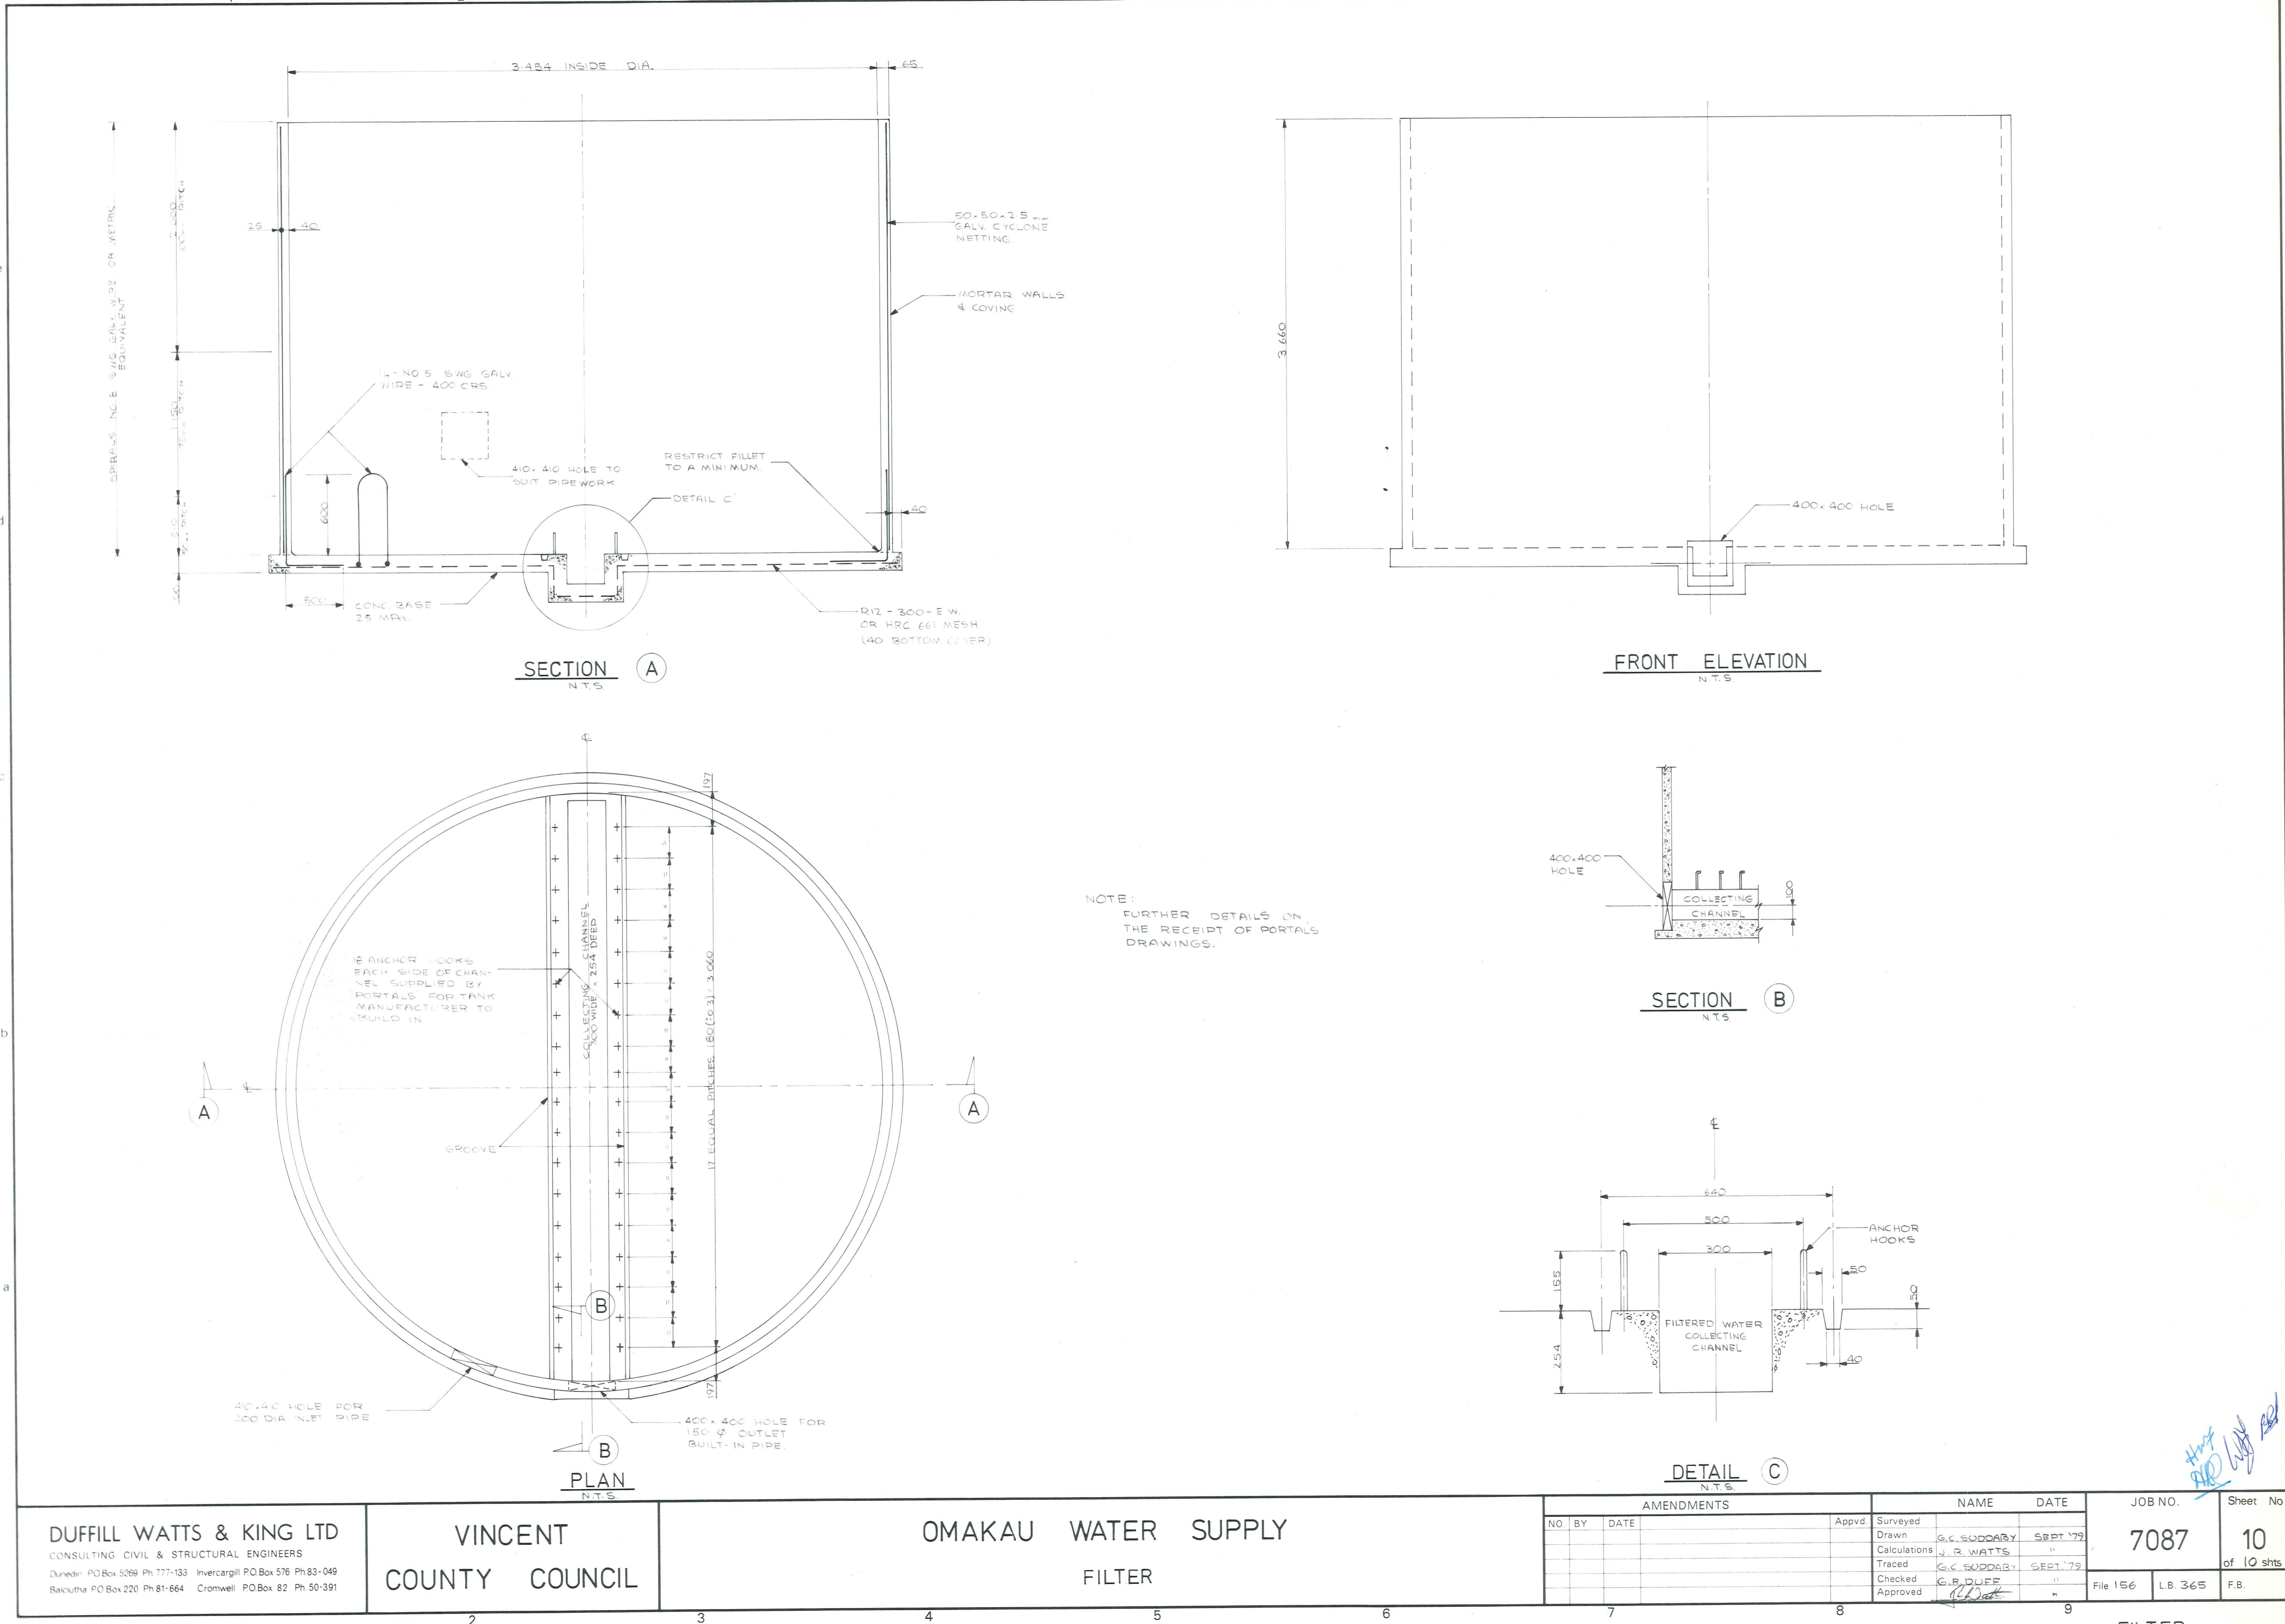

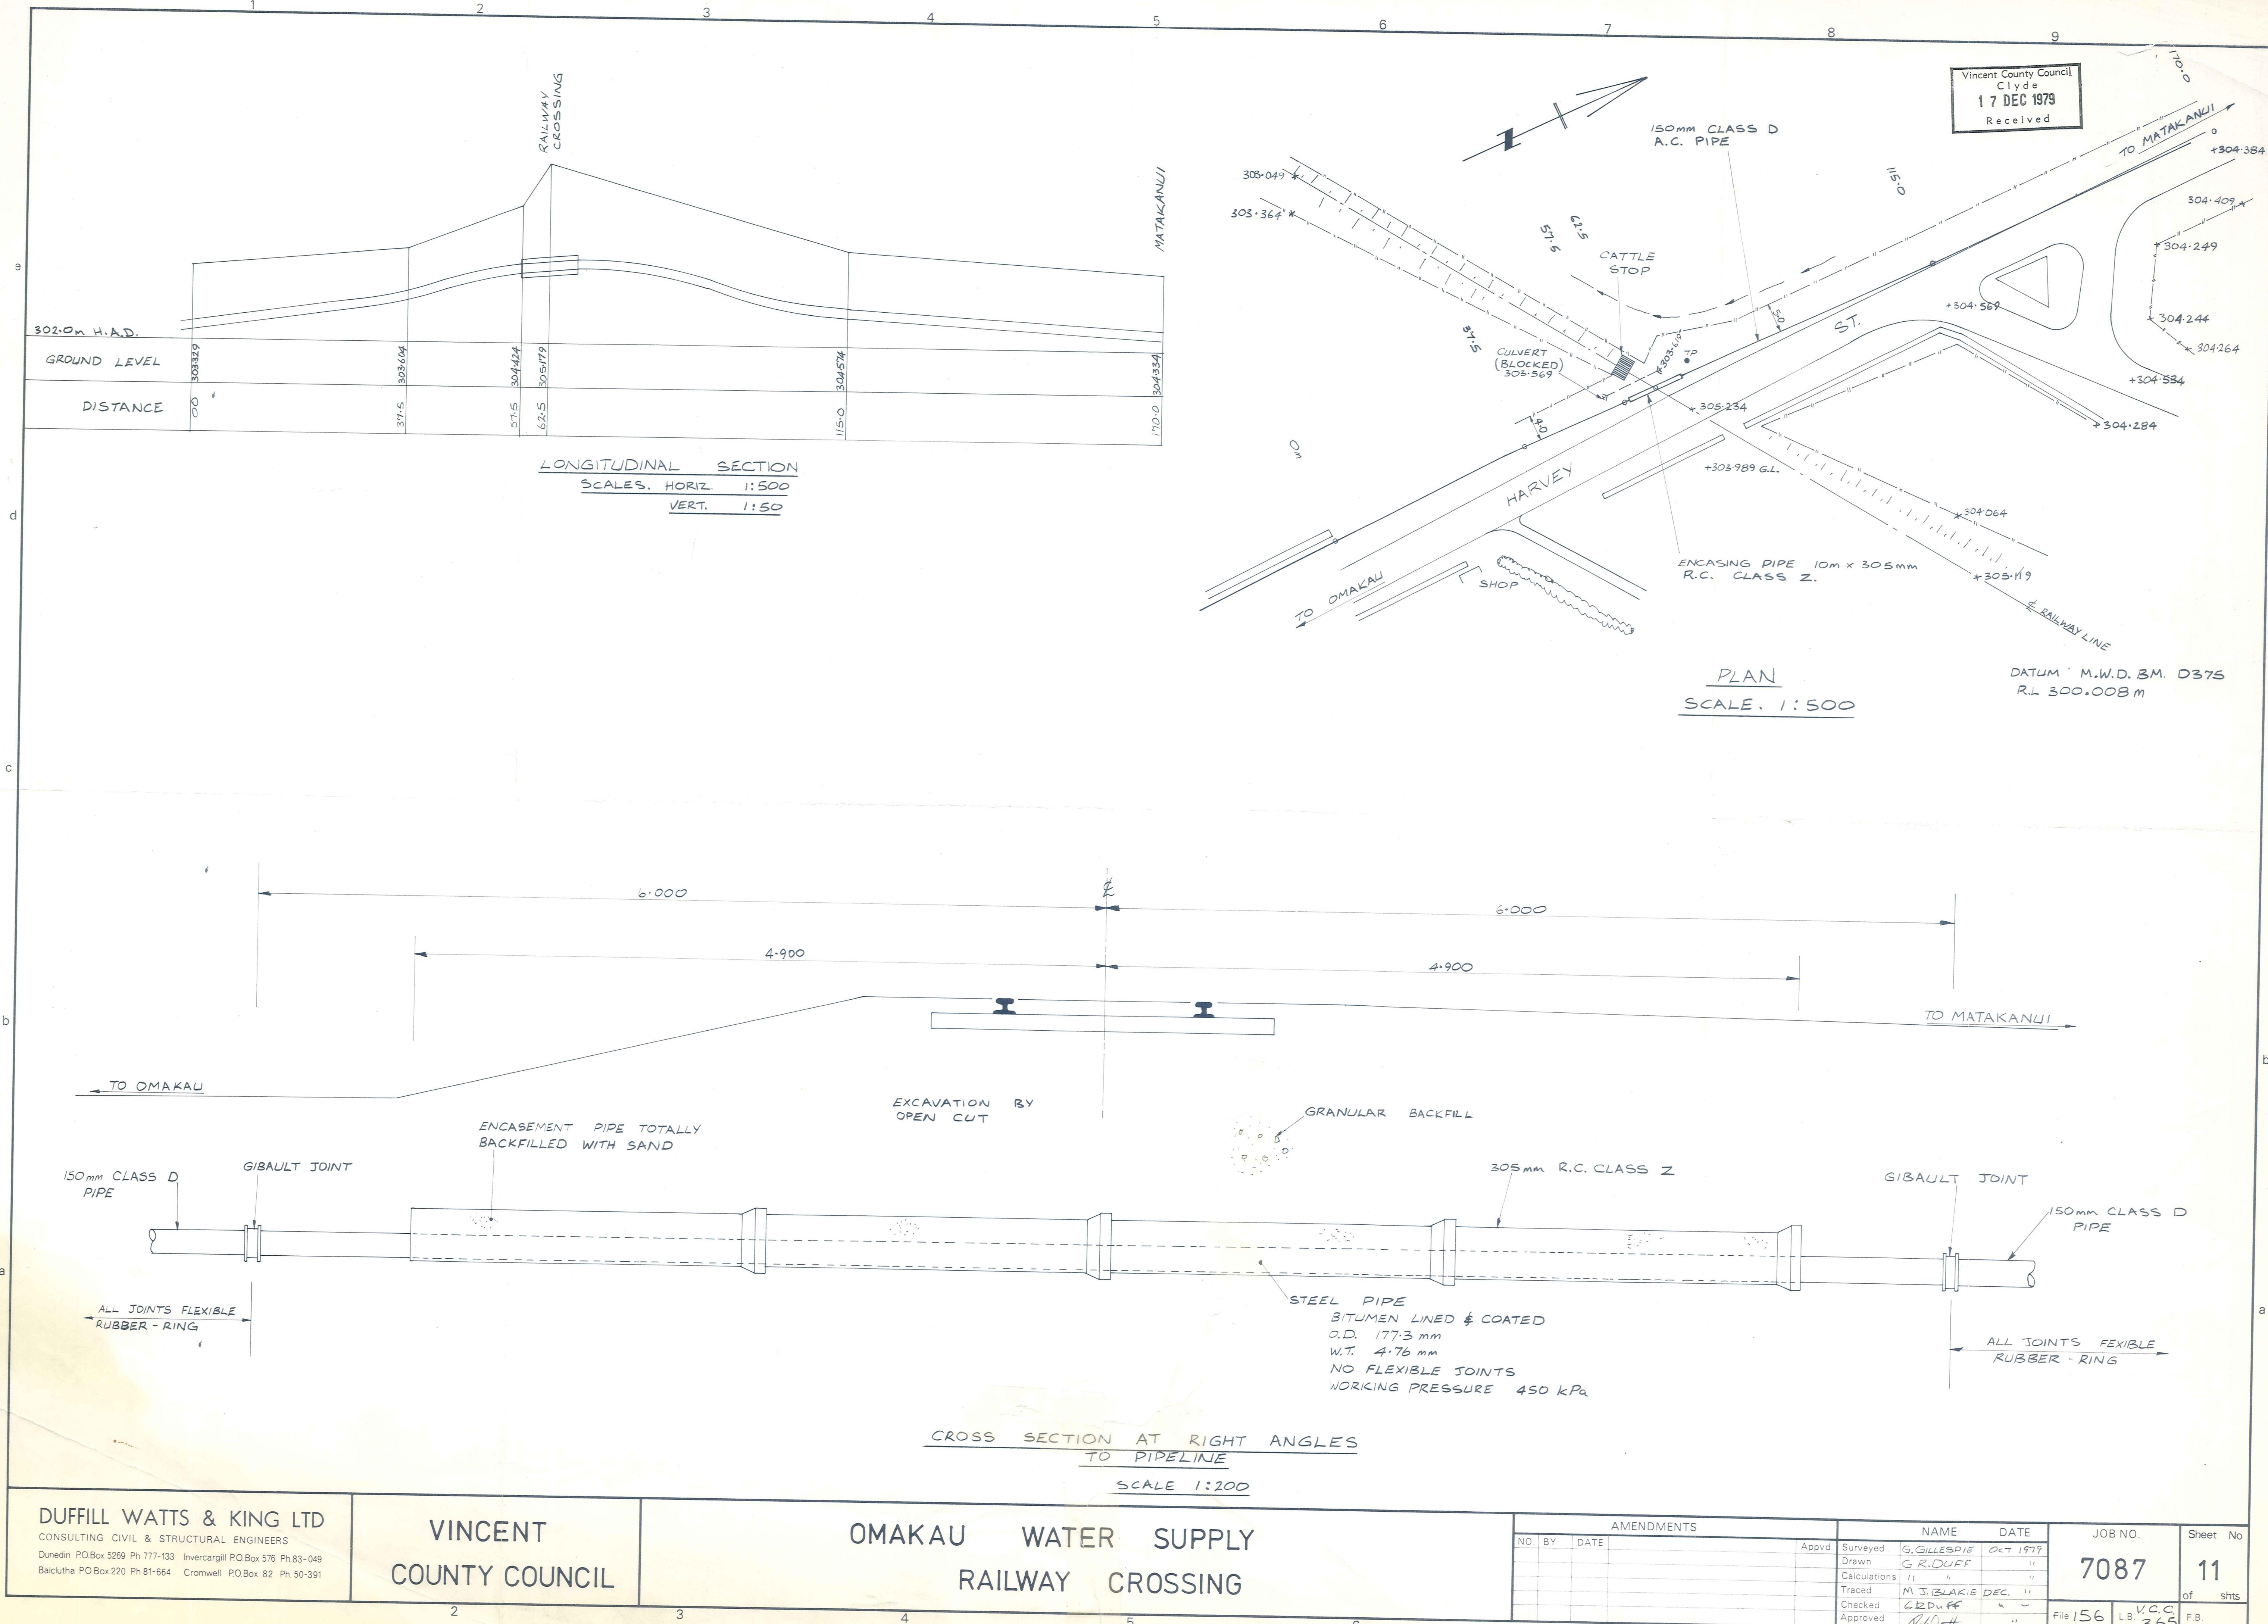

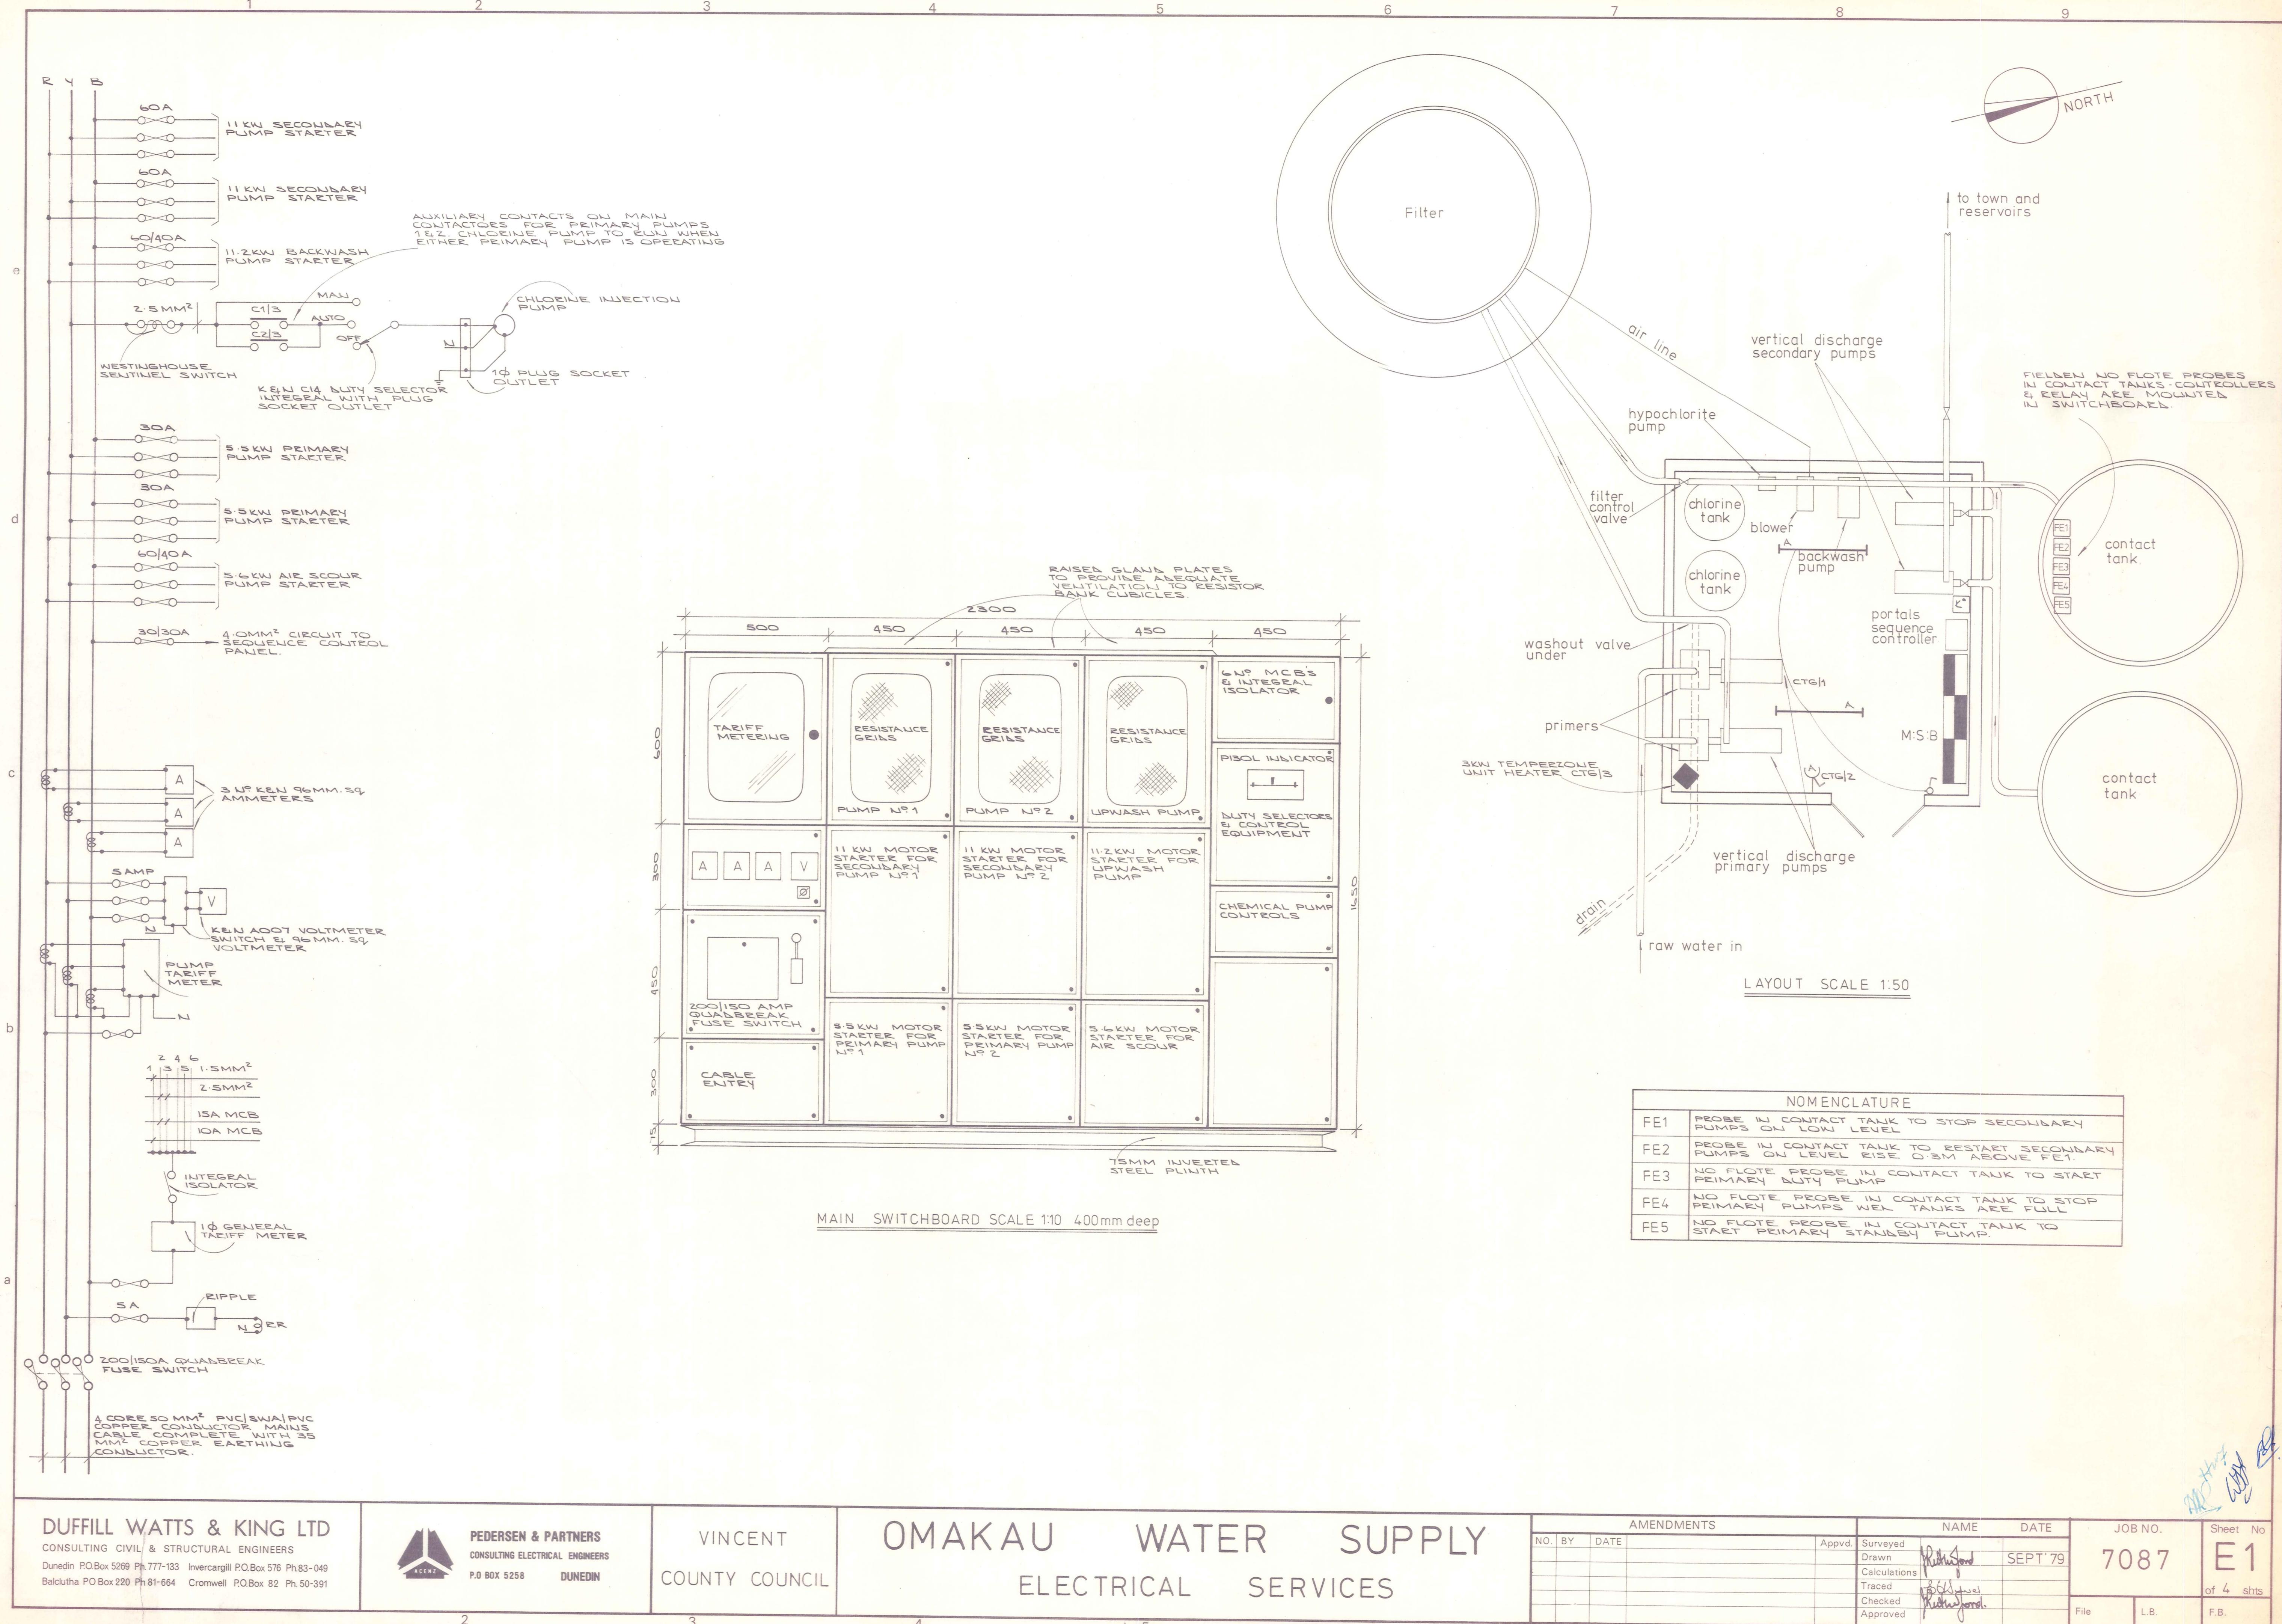

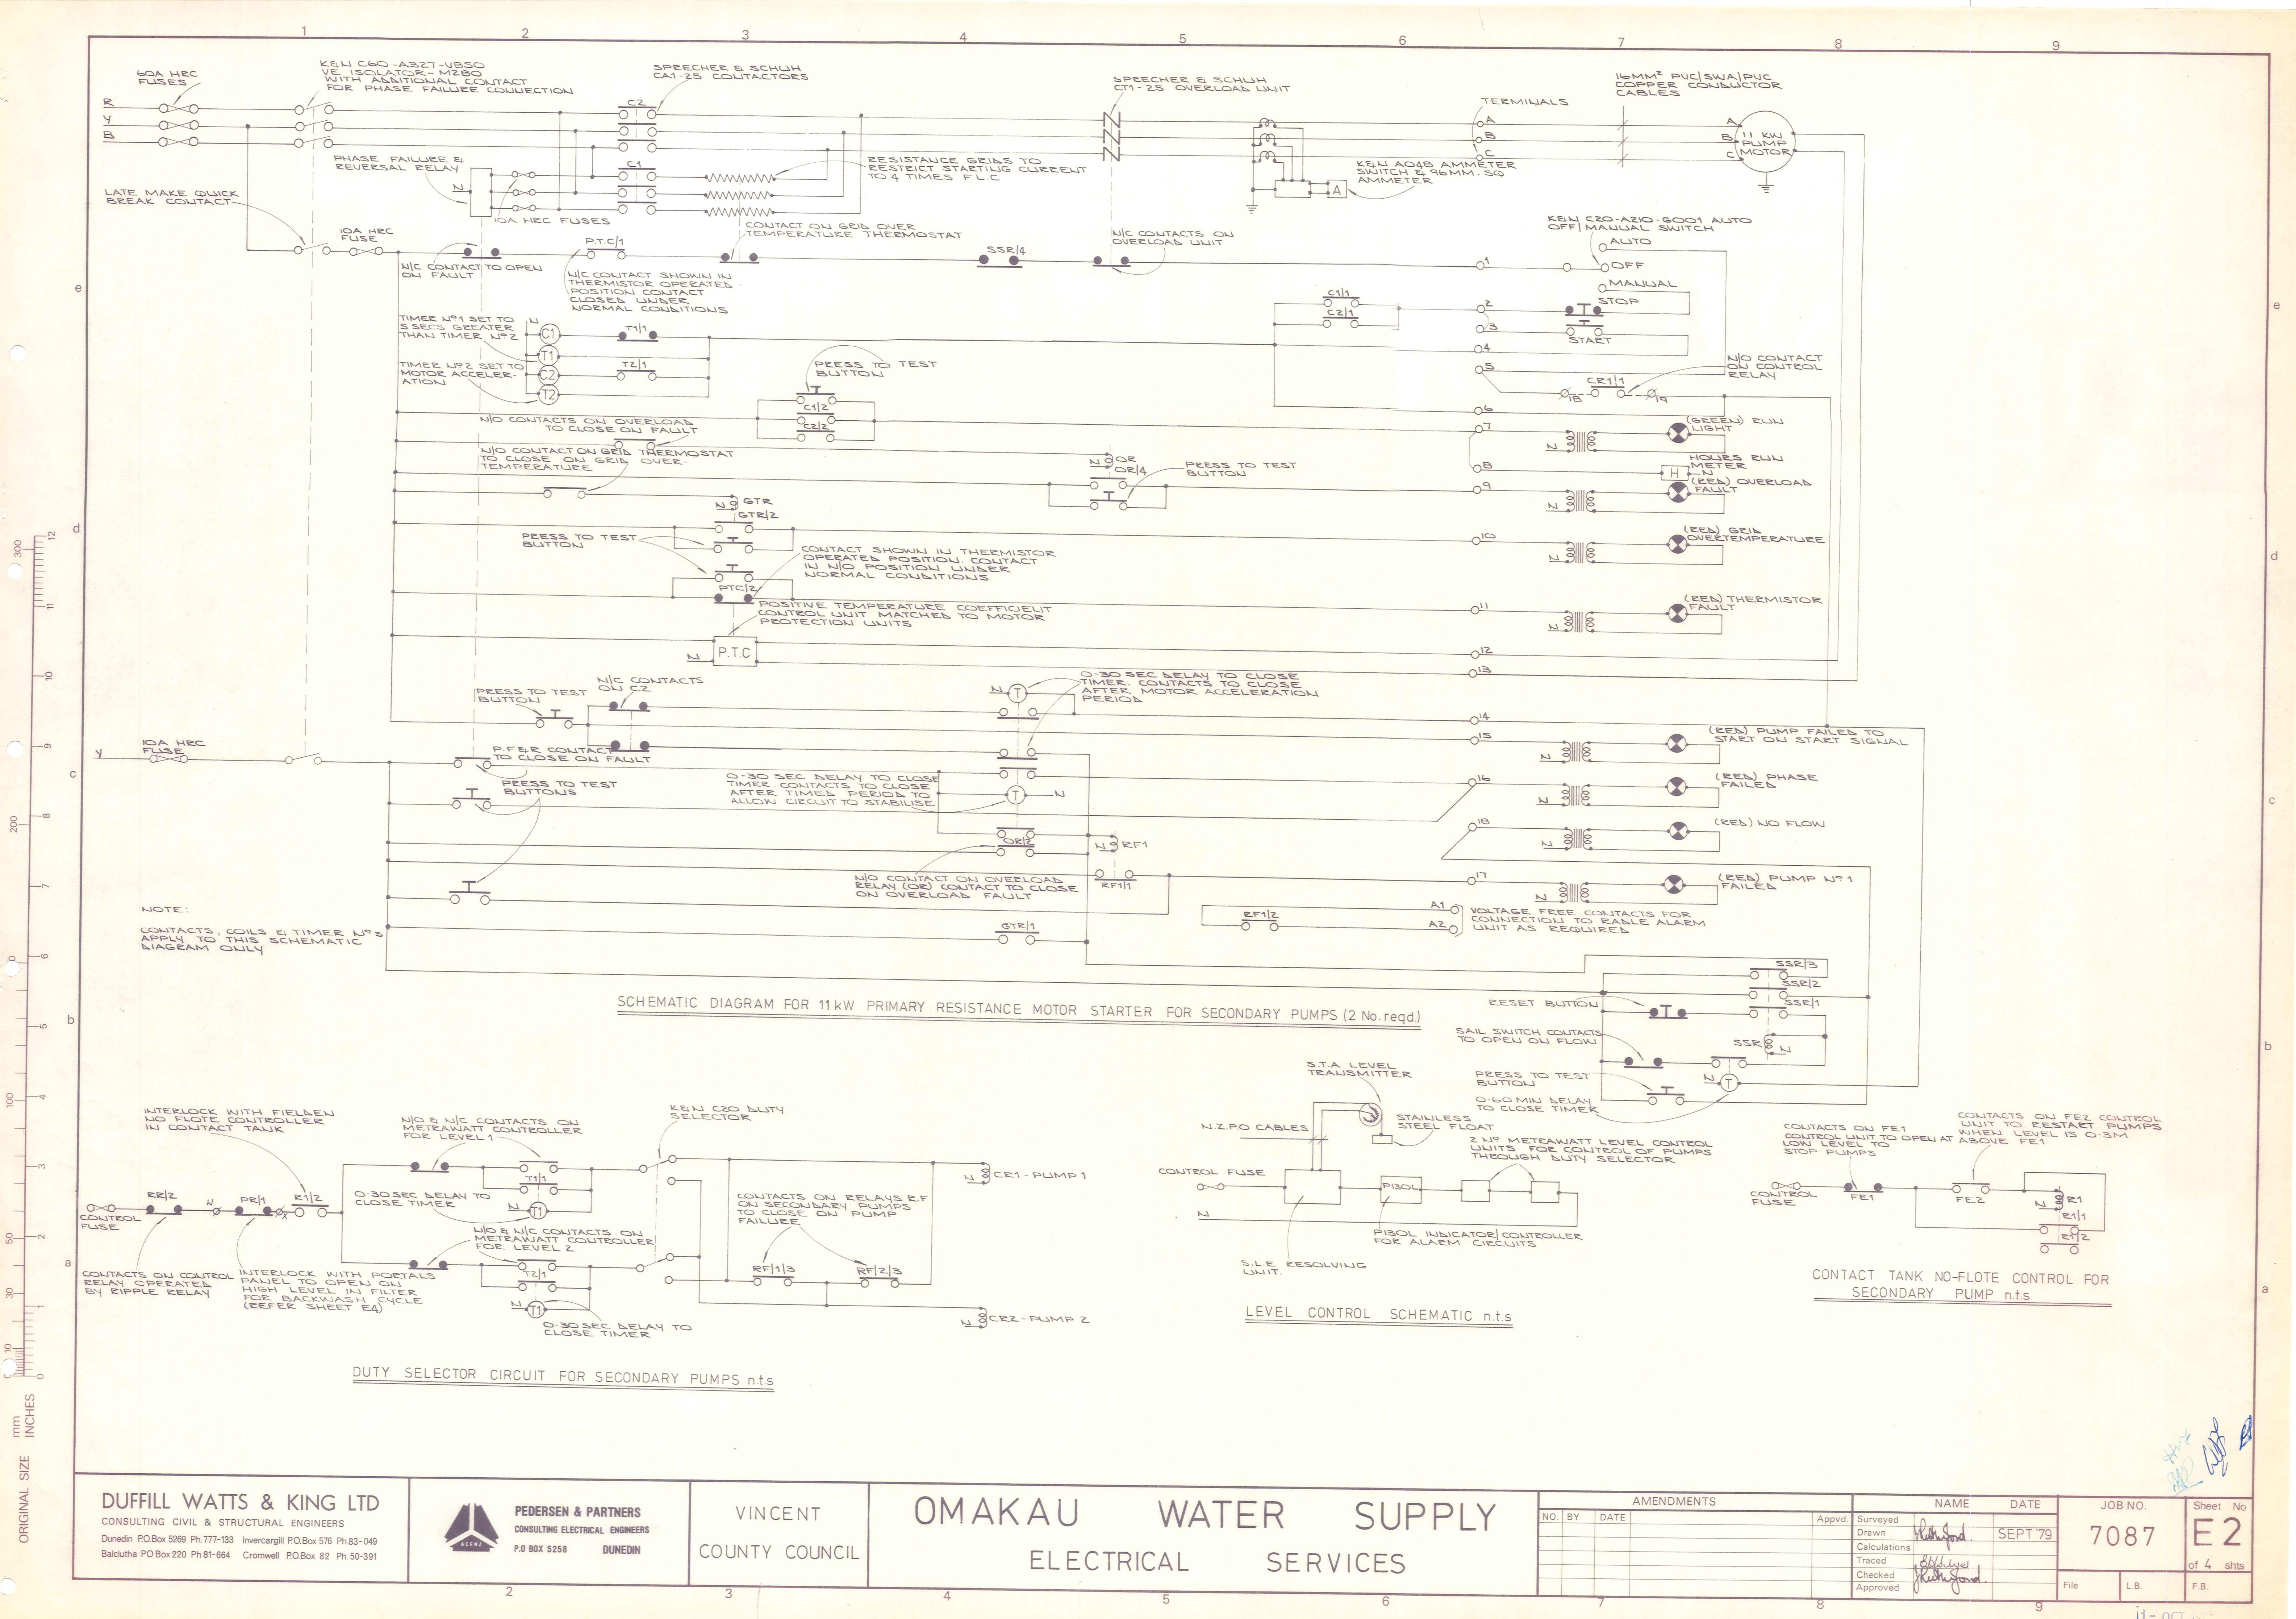

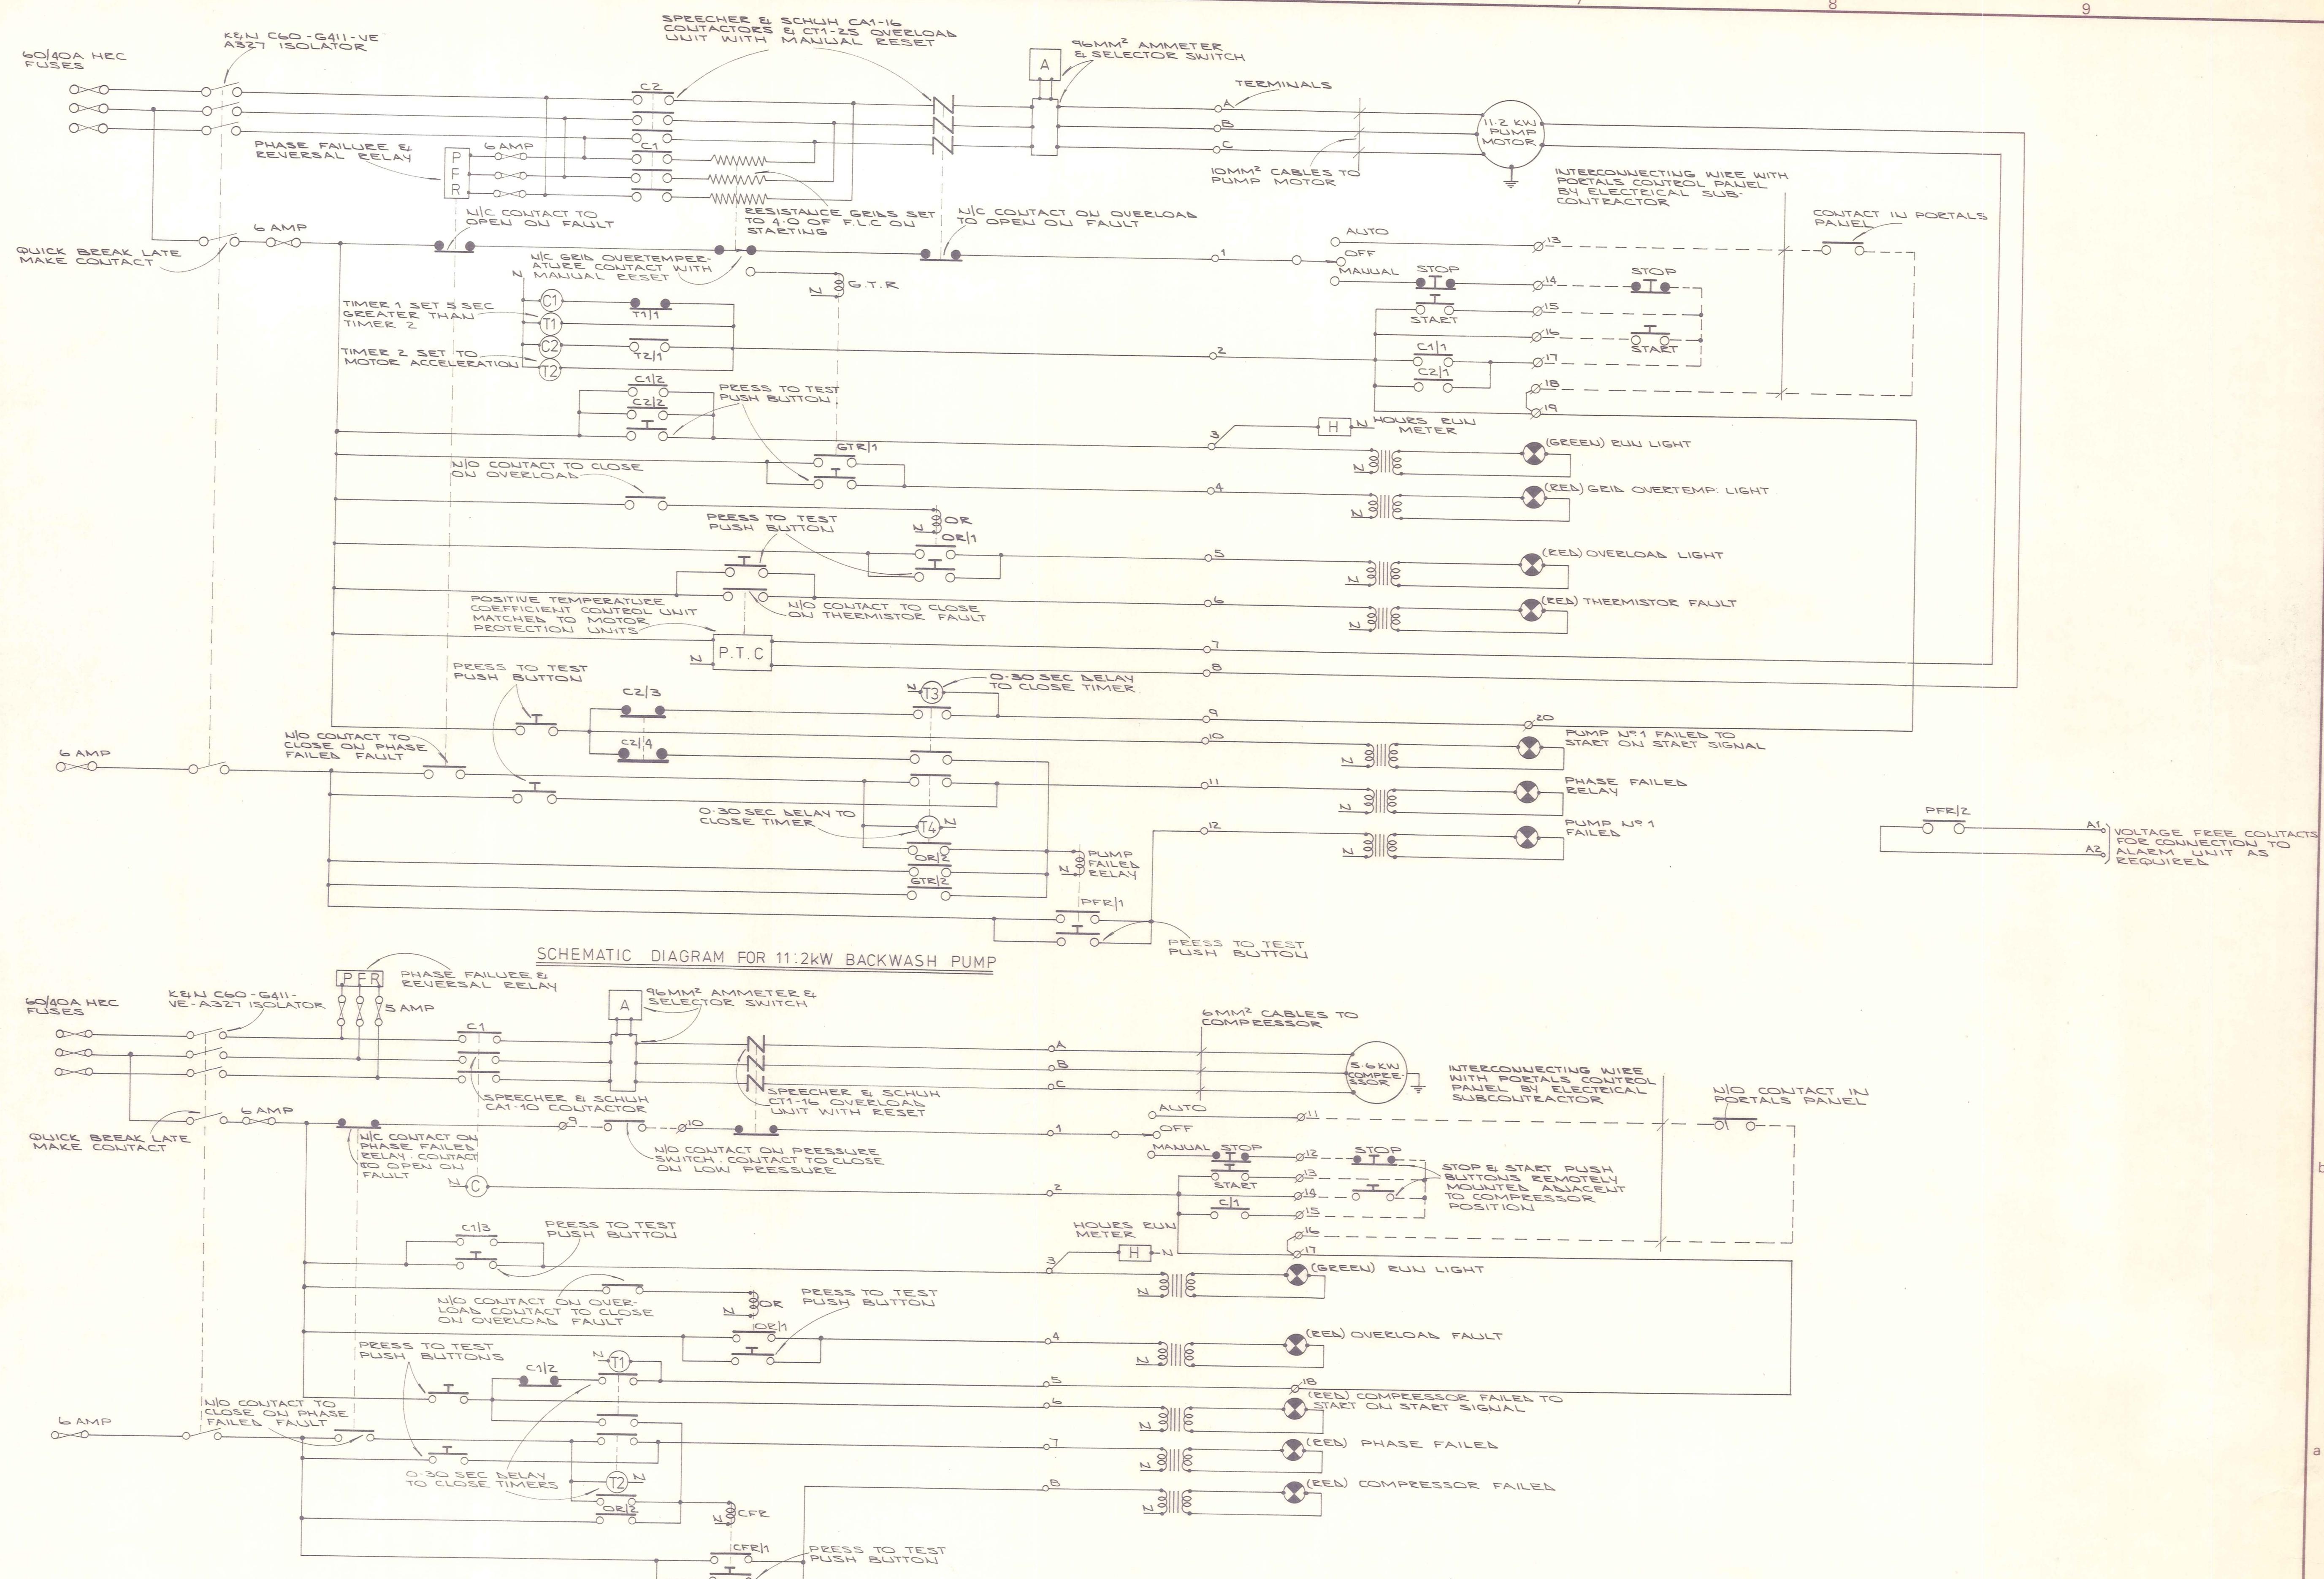

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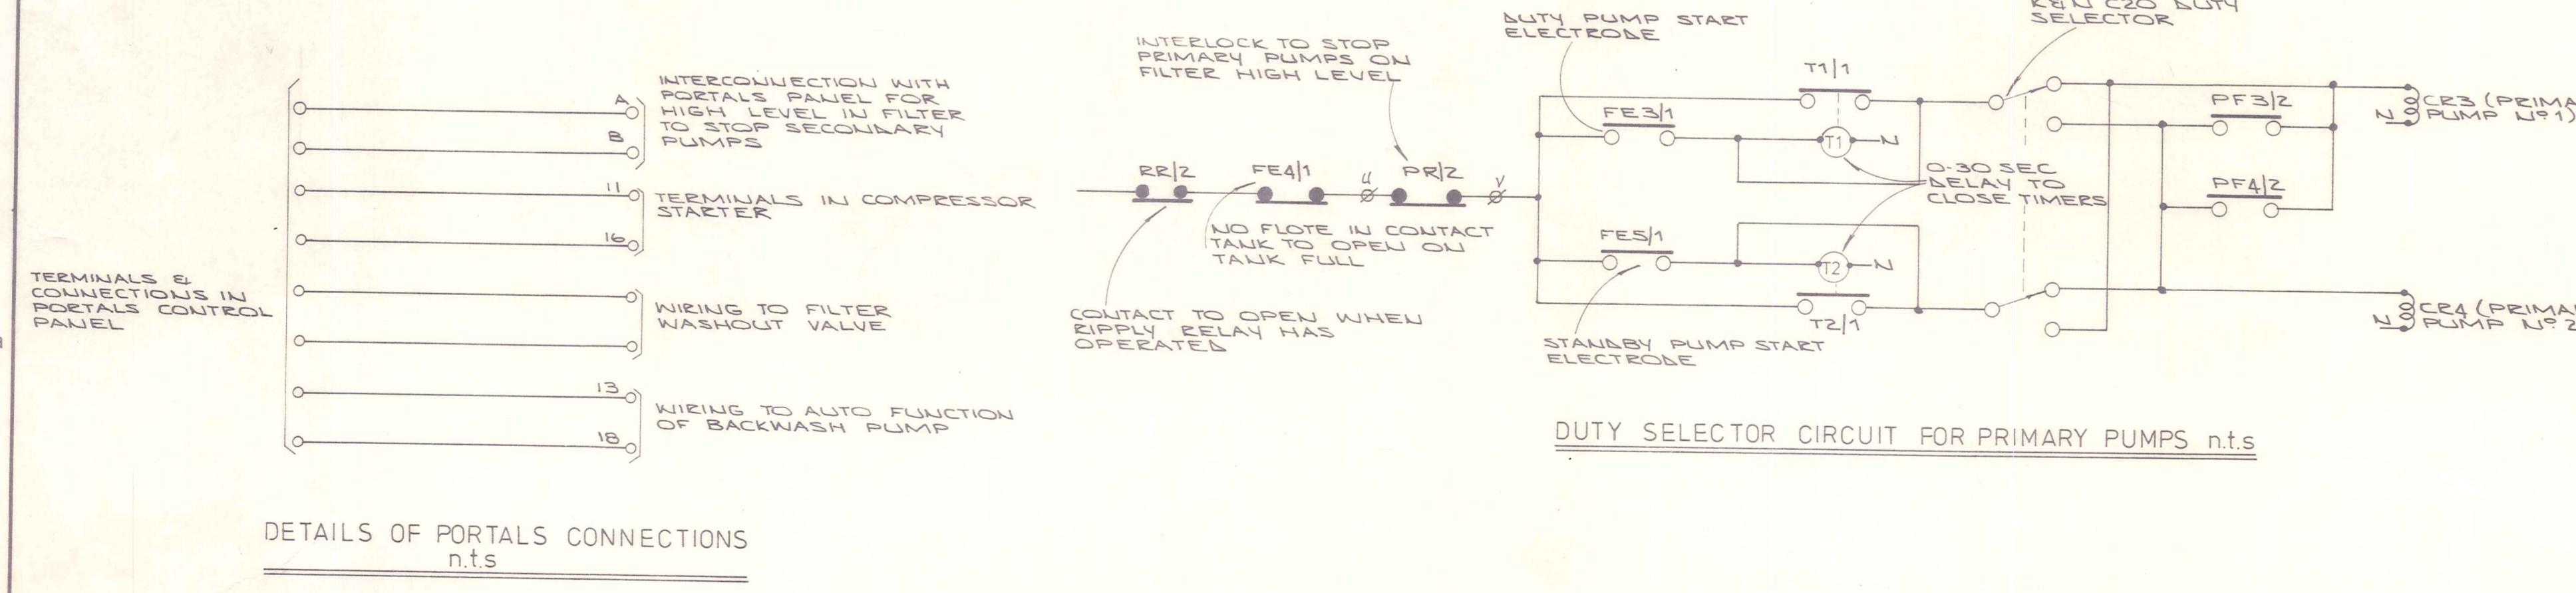
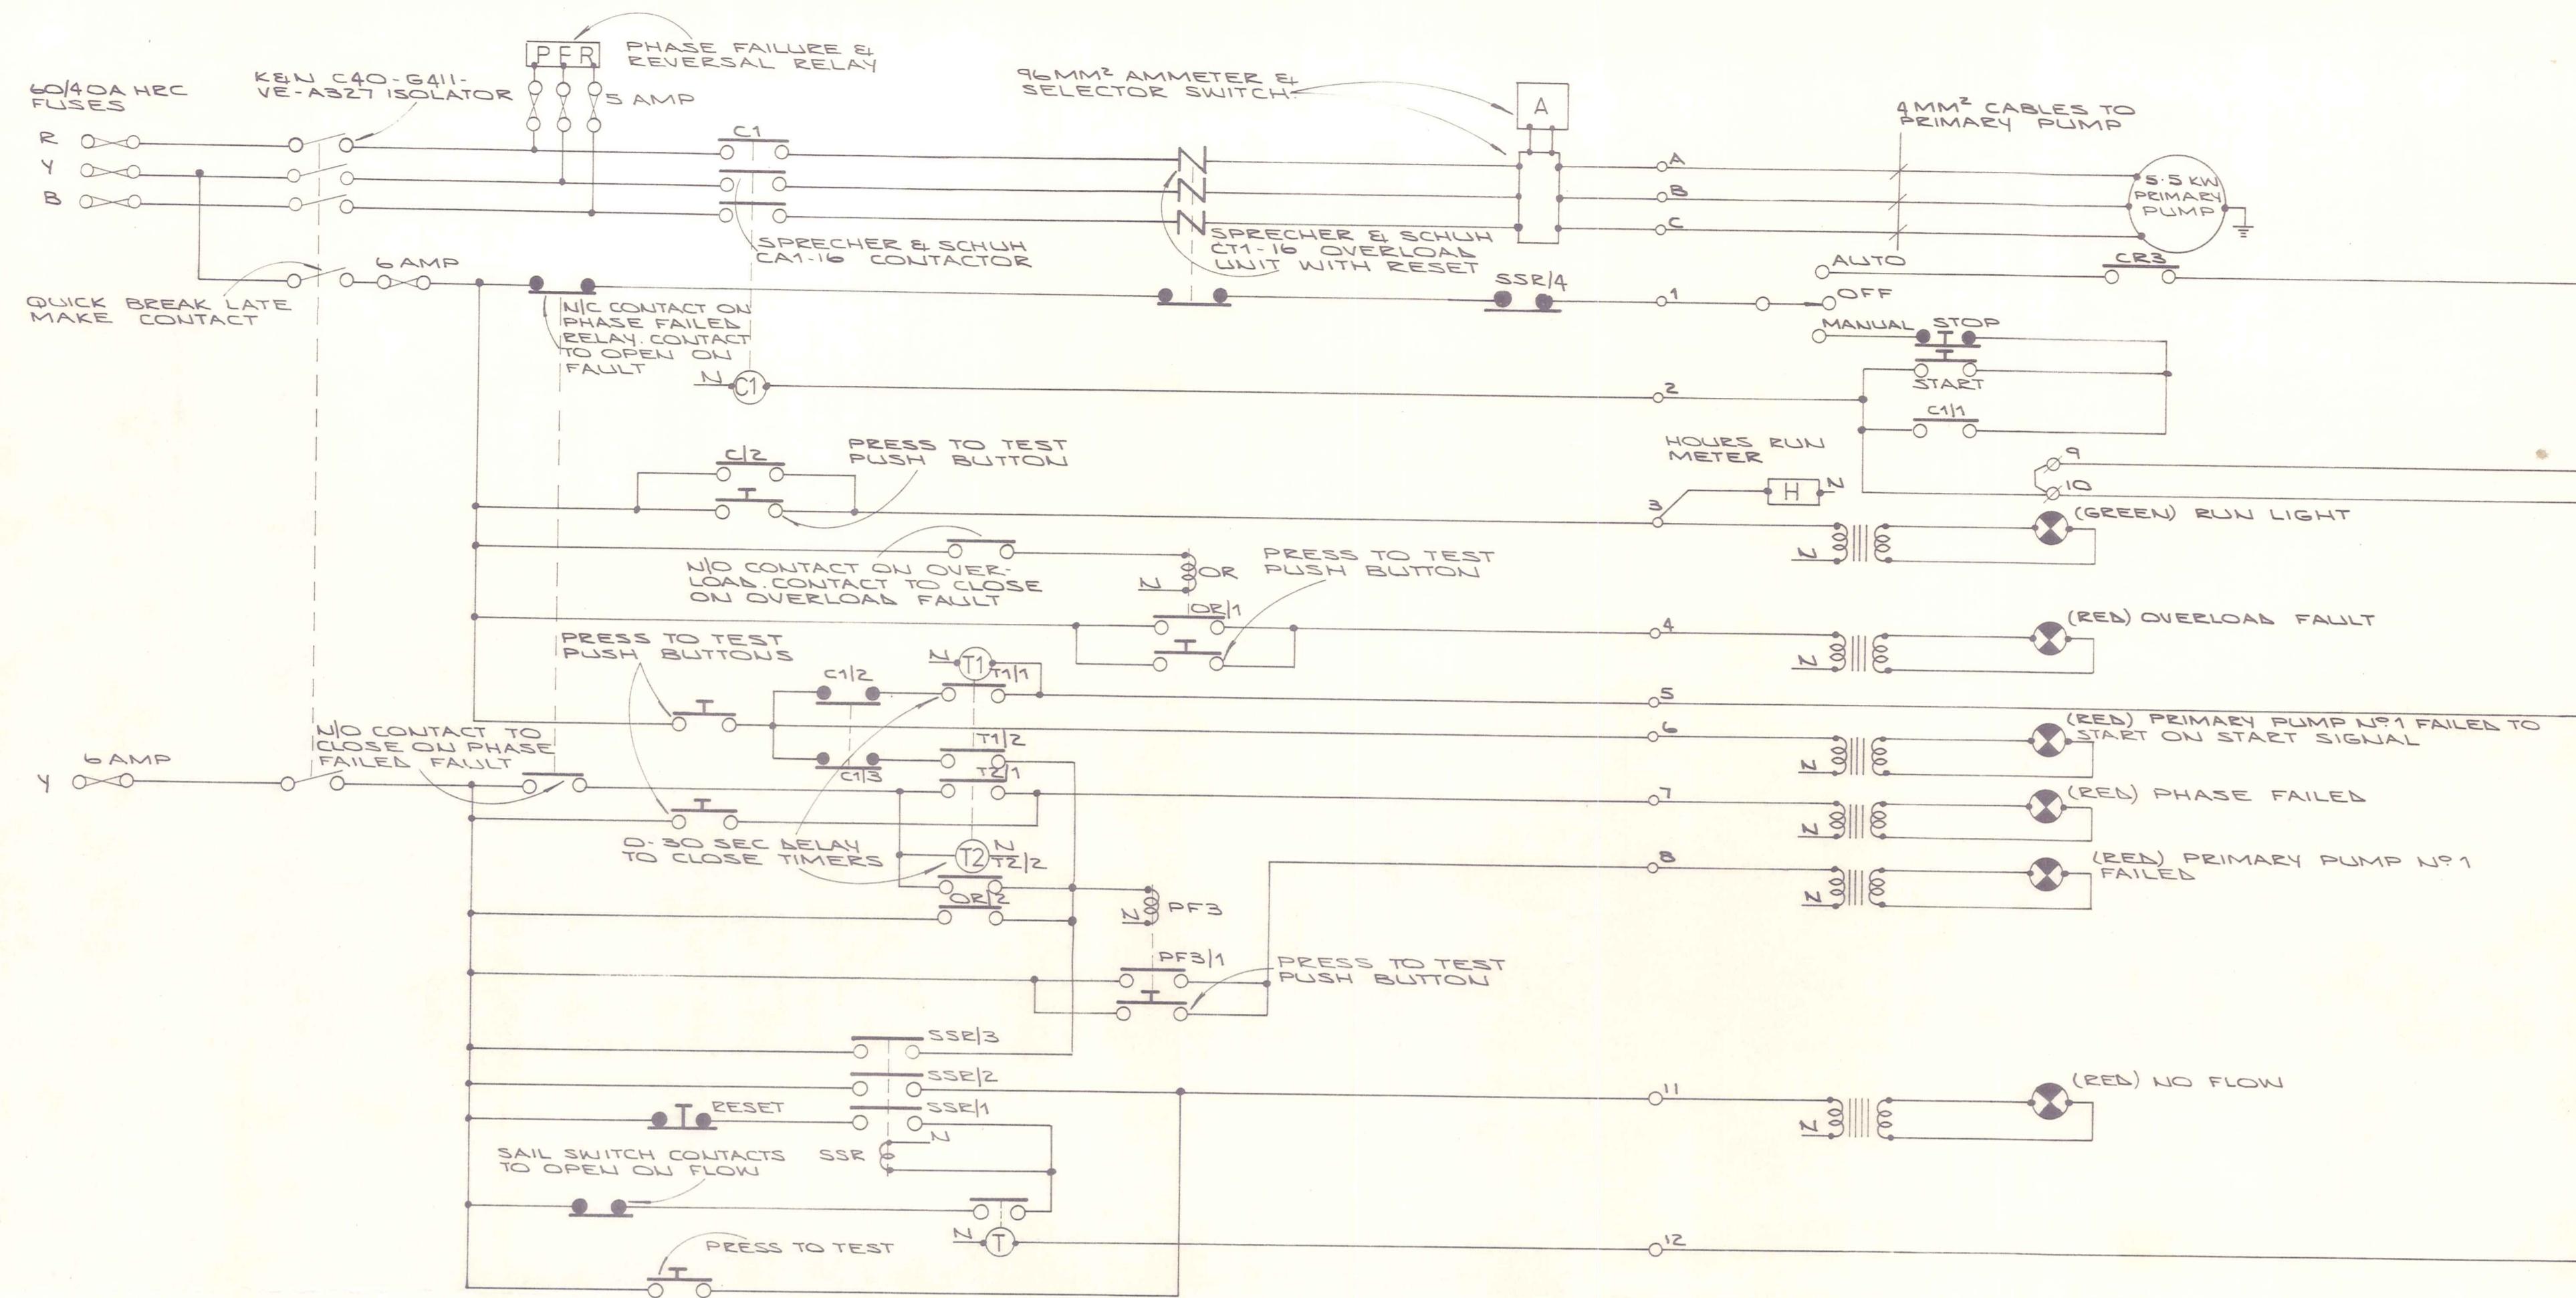
PEDERSEN & PARTNERS
CONSULTING ELECTRICAL ENGINEERS
P.O BOX 5258 DUNEDIN

VINCENT
COUNTY COUNCIL

OMAKAU WATER SUPPLY ELECTRICAL SERVICES

AMENDMENTS	
NO.	BY
	DATE
	Appvd.
	Surveyed
	Drawn
	Calculations
	Traced
	Checked
	Approved

JOB NO.	
7087	Sheet No E3 of 4 shts
File	L.B.
	F.B.



DETAILS OF PORTALS CONNECTIONS
n.t.s.

DUFFILL WATTS & KING LTD
CONSULTING CIVIL & STRUCTURAL ENGINEERS
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OMAKAU WATER SUPPLY ELECTRICAL SERVICES

AMENDMENTS

NO	BY	DATE	Appvd.	Surveyed	Drawn	Calculated	Traced	Checked	Approved	NAME	DATE	JOB NO.	Sheet No
												7087	E4 of 4 shs